SITE CONSTRUCTION PLAN 470 MAIN STREET BOLTON, MA

LEGEND

XIST. FEATURE	DESCRIPTION	EXIST. SYM.	DESCRIPTION
mandam mande destination opposition and employments	STREAMS/RIVERS	ф	LIGHT POLE
	WETLANDS	9	TELEPHONE POLE
	LIMIT OF BUFFER ZONE	Ů	GUY WIRE
LEDGE 100' WELL OFFSET	LEDGE WELL RADIUS	₩.	HYDRANT
xx	WIRE FENCE	(\$)	SEWER MANHOLE
	WOOD FENCE	(STORM WATER MANHOLE
ППП	GUARD RAIL	W	WELL
	CHAIN LINK FENCE		MISCELLANEOUS MANHOLE
STONE WALL	STONE RETAINING WALL	WF A1	WETLAND FLAG
	STONE WALL		0.4.70% 0.4.0%
W	WATER LINE		CATCH BASIN
—— E ———	ELECTRICAL LINE	₩V ⊠	WATER GATE VALVE
D	STORM DRAIN	E	ELECTRICAL METER
OW	EXISTING OVER-HEAD WIRES	TS	TRAFFIC SIGNAL SWITCH
180	EXISTING CONTOUR (INDEX)	Š	SIGN
179	EXISTING CONTOUR (INTERMEDIATE)	TRANS	ELECTRICAL TRANSFORMER
	EXISTING BUILDING/HOUSE	₫	FLAG POLE
TREE LINE	TREE LINE	0	SHRUB

179	EXISTING CONTOUR (INTERMEDIATE)	TRANS	and of the first of the first
	EXISTING BUILDING/HOUSE	<u></u>	FLAG POLE SHRUB
TREE LINE	TREE LINE		SINOB
PROP. FEATURE	DESCRIPTION	PROP. SYM.	DESCRIPTION
	REPLICATED WETLANDS	V =+=	PROPOSED LIGHT POLE
	PROPERTY LINE	9	PROPOSED TELEPHONE POLE
	EASEMENT LINE	.	PROPOSED HYDRANT
CONTROL OFFICERS AND ADDRESS SACRATES ASSESSED ASSESSED.	HAYBALES	© ^{SMH−1}	
$a_{1000000000000000000000000000000000000$	WIRE FENCE	©	PROPOSED SANITARY MANHOLE
		©DMH−1	PROPOSED STORM WATER MANHOLE
Contract parties is contracted. The must be selected as a contract and the contract as a contract as contract.	WOOD FENCE		
RET. WALL (CONC.)	CHAIN LINK FENCE	\bigcirc	PROPOSED TELEPHONE MANHOLE
	POURED CONCRETE RETAINING WALL		PROPOSED ELECTRICAL MANHOLE
RET. WALL (BLOCK)	CONC. BLOCK RETAINING WALL	©CB-1	PROPOSED CATCH BASIN
RET. WALL (STONE)	STONE RETAINING WALL	DCB-1	PROPOSED CATCH BASIN
w	PROPOSED WATER LINE		PROPOSED DOUBLE CATCH BASIN
F	PROPOSED ELECTRICAL LINE	GV	PROPOSED WATER GATE VALVE
	PROPOSED ELECTRICAL DIAE	guernama.	
	PROPOSED SANITARY SEWER	T	PROPOSED ELECTRICAL TRANSFORMER
	PROPOSED STORM DRAIN	E	PROPOSED ELECTRICAL JUNCTION BOX
RD	PROPOSED ROOF DRAIN	TS	PROPOSED TRAFFIC SIGNAL SWITCH
UD	PROPOSED UNDER DRAIN		DRADOCED CION
BCCB	PROPOSED BACK CAPE COD BERM	S	PROPOSED SIGN
EOP	PROPOSED EDGE OF PAVEMENT	◆ ^{B-1}	BORING
	PROPOSED UNPAVED ROAD	گر FES	HANDICAPPED SPACE
180	PROPOSED CONTOUR (INDEX)		PROPOSED FLARED END SECTION
179	PROPOSED CONTOUR (INTERMEDIATE		PROPOSED RIPRAP
175x5	PROPOSED SPOT ELEVATION	\odot	STANDARD TREE
3	PROPOSED BUILDING/HOUSE	E . Z	PINE TREE
TREE LINE	and the same of th	The same	

CHEET INDEX


BOLTON, MASSACHUSETTS 01740

	LATEST	
SHEET TITLE	REVISION	
TITLE SHEET	1/19/16	
	1/19/16 1/19/16	
	1/19/16	
EROSION CONTROL PLAN	1/19/16	
DETAIL SHEET	1/19/16	
DETAIL SHEET	1/19/16	
DETAIL SHEET	1/19/16	
SEPTIC SYSTEM DESIGN	(NOT INCLUDED	
SEPTIC SYSTEM DESIGN	(NOT INCLUDED	
LANDSCAPE DETAIL	12/3/15	
	TITLE SHEET EXISTING CONDITIONS PLAN LAYOUT & UTILITIES PLAN GRADING & DRAINAGE PLAN EROSION CONTROL PLAN DETAIL SHEET DETAIL SHEET DETAIL SHEET SEPTIC SYSTEM DESIGN SEPTIC SYSTEM DESIGN	

ABBREVIATIONS

ABB.	DESCRIPTION
ATM	ATMOSPHERIC TANK
UD	UNDERDRAIN
FD	FOUNDATION DRAIN
F.S.	FIRE SERVICE
DOM.	DOMESTIC WATER SERVICE
B.0	WATER BLOW OFF
DMH	DRAIN MANHOLE
SMH	SEWER MANHOLE
ST	SEPTIC TANK
PC	PUMP CHAMBER
DP1	DRAIN PIPE ID
SP1	SEWER PIPE ID
DB	DISTRIBUTION BOX
SC	STORMCEPTOR CATCH BASIN
GAL	GALLON
TOF	TOP OF FOUNDATION
EL.	ELEVATION
INV.	INVERT
WSO	WATER SHUTOFF
BCCB	BITUMINOUS CAPE COD BERN
RET.	RETAINING WALL
C.O.	CLEAN OUT
INSP. T.	INSPECTION PORT

TITLE SHEET

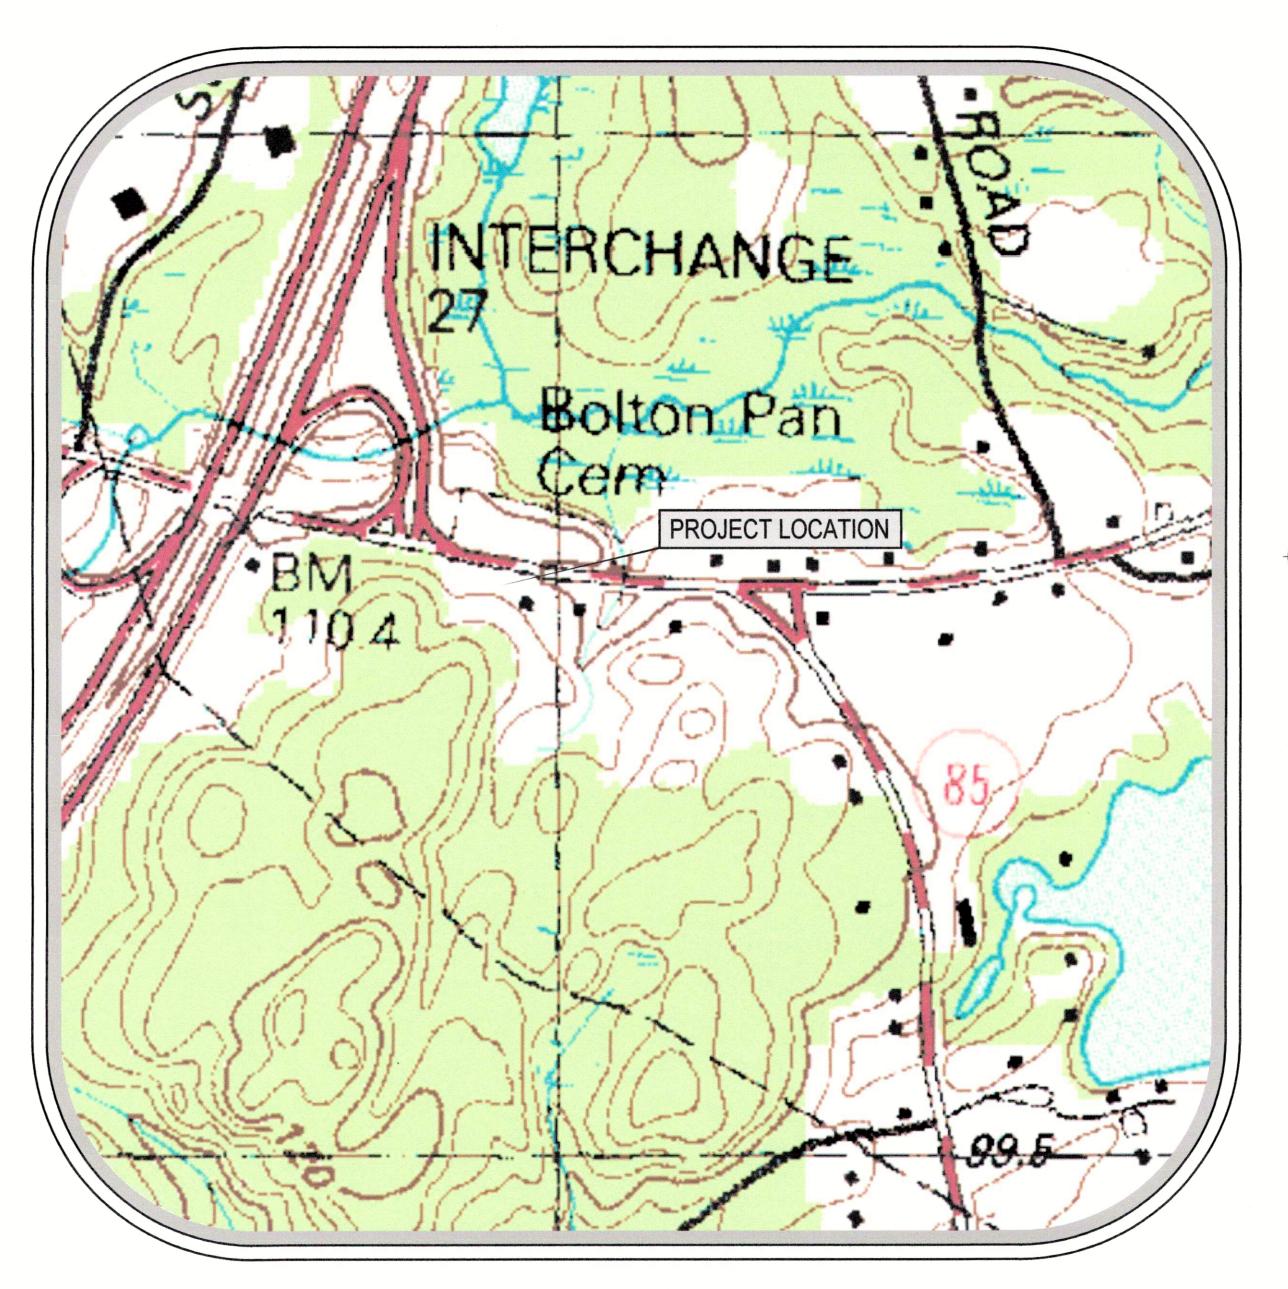

GENERAL NOTES/REFERENCES:

- DESIGN GROUP, INC. ELEVATIONS REFER TO ASSUMED DATUM.
- RESOURCE AREAS AS DEFINED BY THE MASSACHUSETTS WETLANDS PROTECTION ACT AND THE TOWN OF BOLTON WETLANDS PROTECTION BYLAW WERE DELINEATED BY DUCHARME & DILLIS CIVIL DESIGN GROUP, INC. AND CONFIRMED
- 4. A PORTION OF THE PROPOSED WORK SITE CONTAINS AN INTERIM WELLHEAD PROTECTION AREA (IWPA).
 5. THE PROPOSED WORK DOES FALL WITH IN AN NHESP ESTIMATED HABITAT OF RARE WILDLIFE OR PRIORITY HABITAT OF
- 6. THE PROJECT IS NOT LOCATED WITHIN ANY "AREA OF CRITICAL ENVIRONMENTAL CONCERN" (ACEC).
 7. THE CONTRACTOR SHALL CALL DIG SAFE 1-888-DIG-SAFE PRIOR TO CONSTRUCTION IN ACCORDANCE WITH STATE

- 9. CONTRACTOR TO FIELD VERIFY LOCATION OF EXISTING FEATURES PRIOR TO COMMENCEMENT OF WORK.

ZONING INFORMATION

	BUSINESS MIXED USE VILLAGE OVERLAY DISTRICT	
DESCRIPTION	REQUIRED(LB)	PROVIDED
MIN. LAND AREA	1.5 AC.	1.5 AC.
MIN. FRONTAGE	200'	200'
MIN. WIDTH	150'	~155'
MIN. FRONT YARD	150'	52.9' (VARIANCE)
MIN. SIDE/REAR YARD	50'	25.0' (VARIANCE)
MAX. BLDG. HEIGHT	32'	<32'
MAX. BLDG./LOT COVERAG	E 8%	5.2%
MAX. IMPERVIOUS/LOT COV	VERAGE 50%	18.8%

PARKING SCHEDULE

2.568 SF RETAIL BUILDING	REQUIRED	PROVIDED
(§ 250–17 – 3 SF PARKING AREA / 1 SF BUILDING AREA)	7,704 SF	7,913 SF (x3.08
PARKING SPACES TOTAL SPACES		23 SPACES
HP ACCESSIBLE SPACES (521 CMR 23.2)	2 SPACE	2 SPACES

LOCUS MAP SCALE: 1" = 500'.

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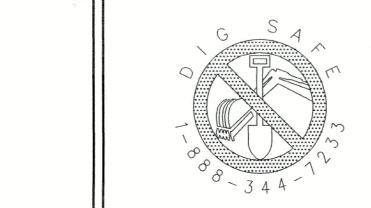
DUCHARME & DILLIS Civil Design Group, Inc.


CIVIL ENGINEERS. LAND SURVEYORS. WETLAND CONSULTANTS 1092 MAIN STREET, P.O. BOX 428

PHONE: (978) 779-6091 FAX: (978) 779-0260 www.DucharmeandDillis.com


HOUDE REALTY TRUST 476 MAIN STREET BOLTON, MASSACHUSETTS 01740


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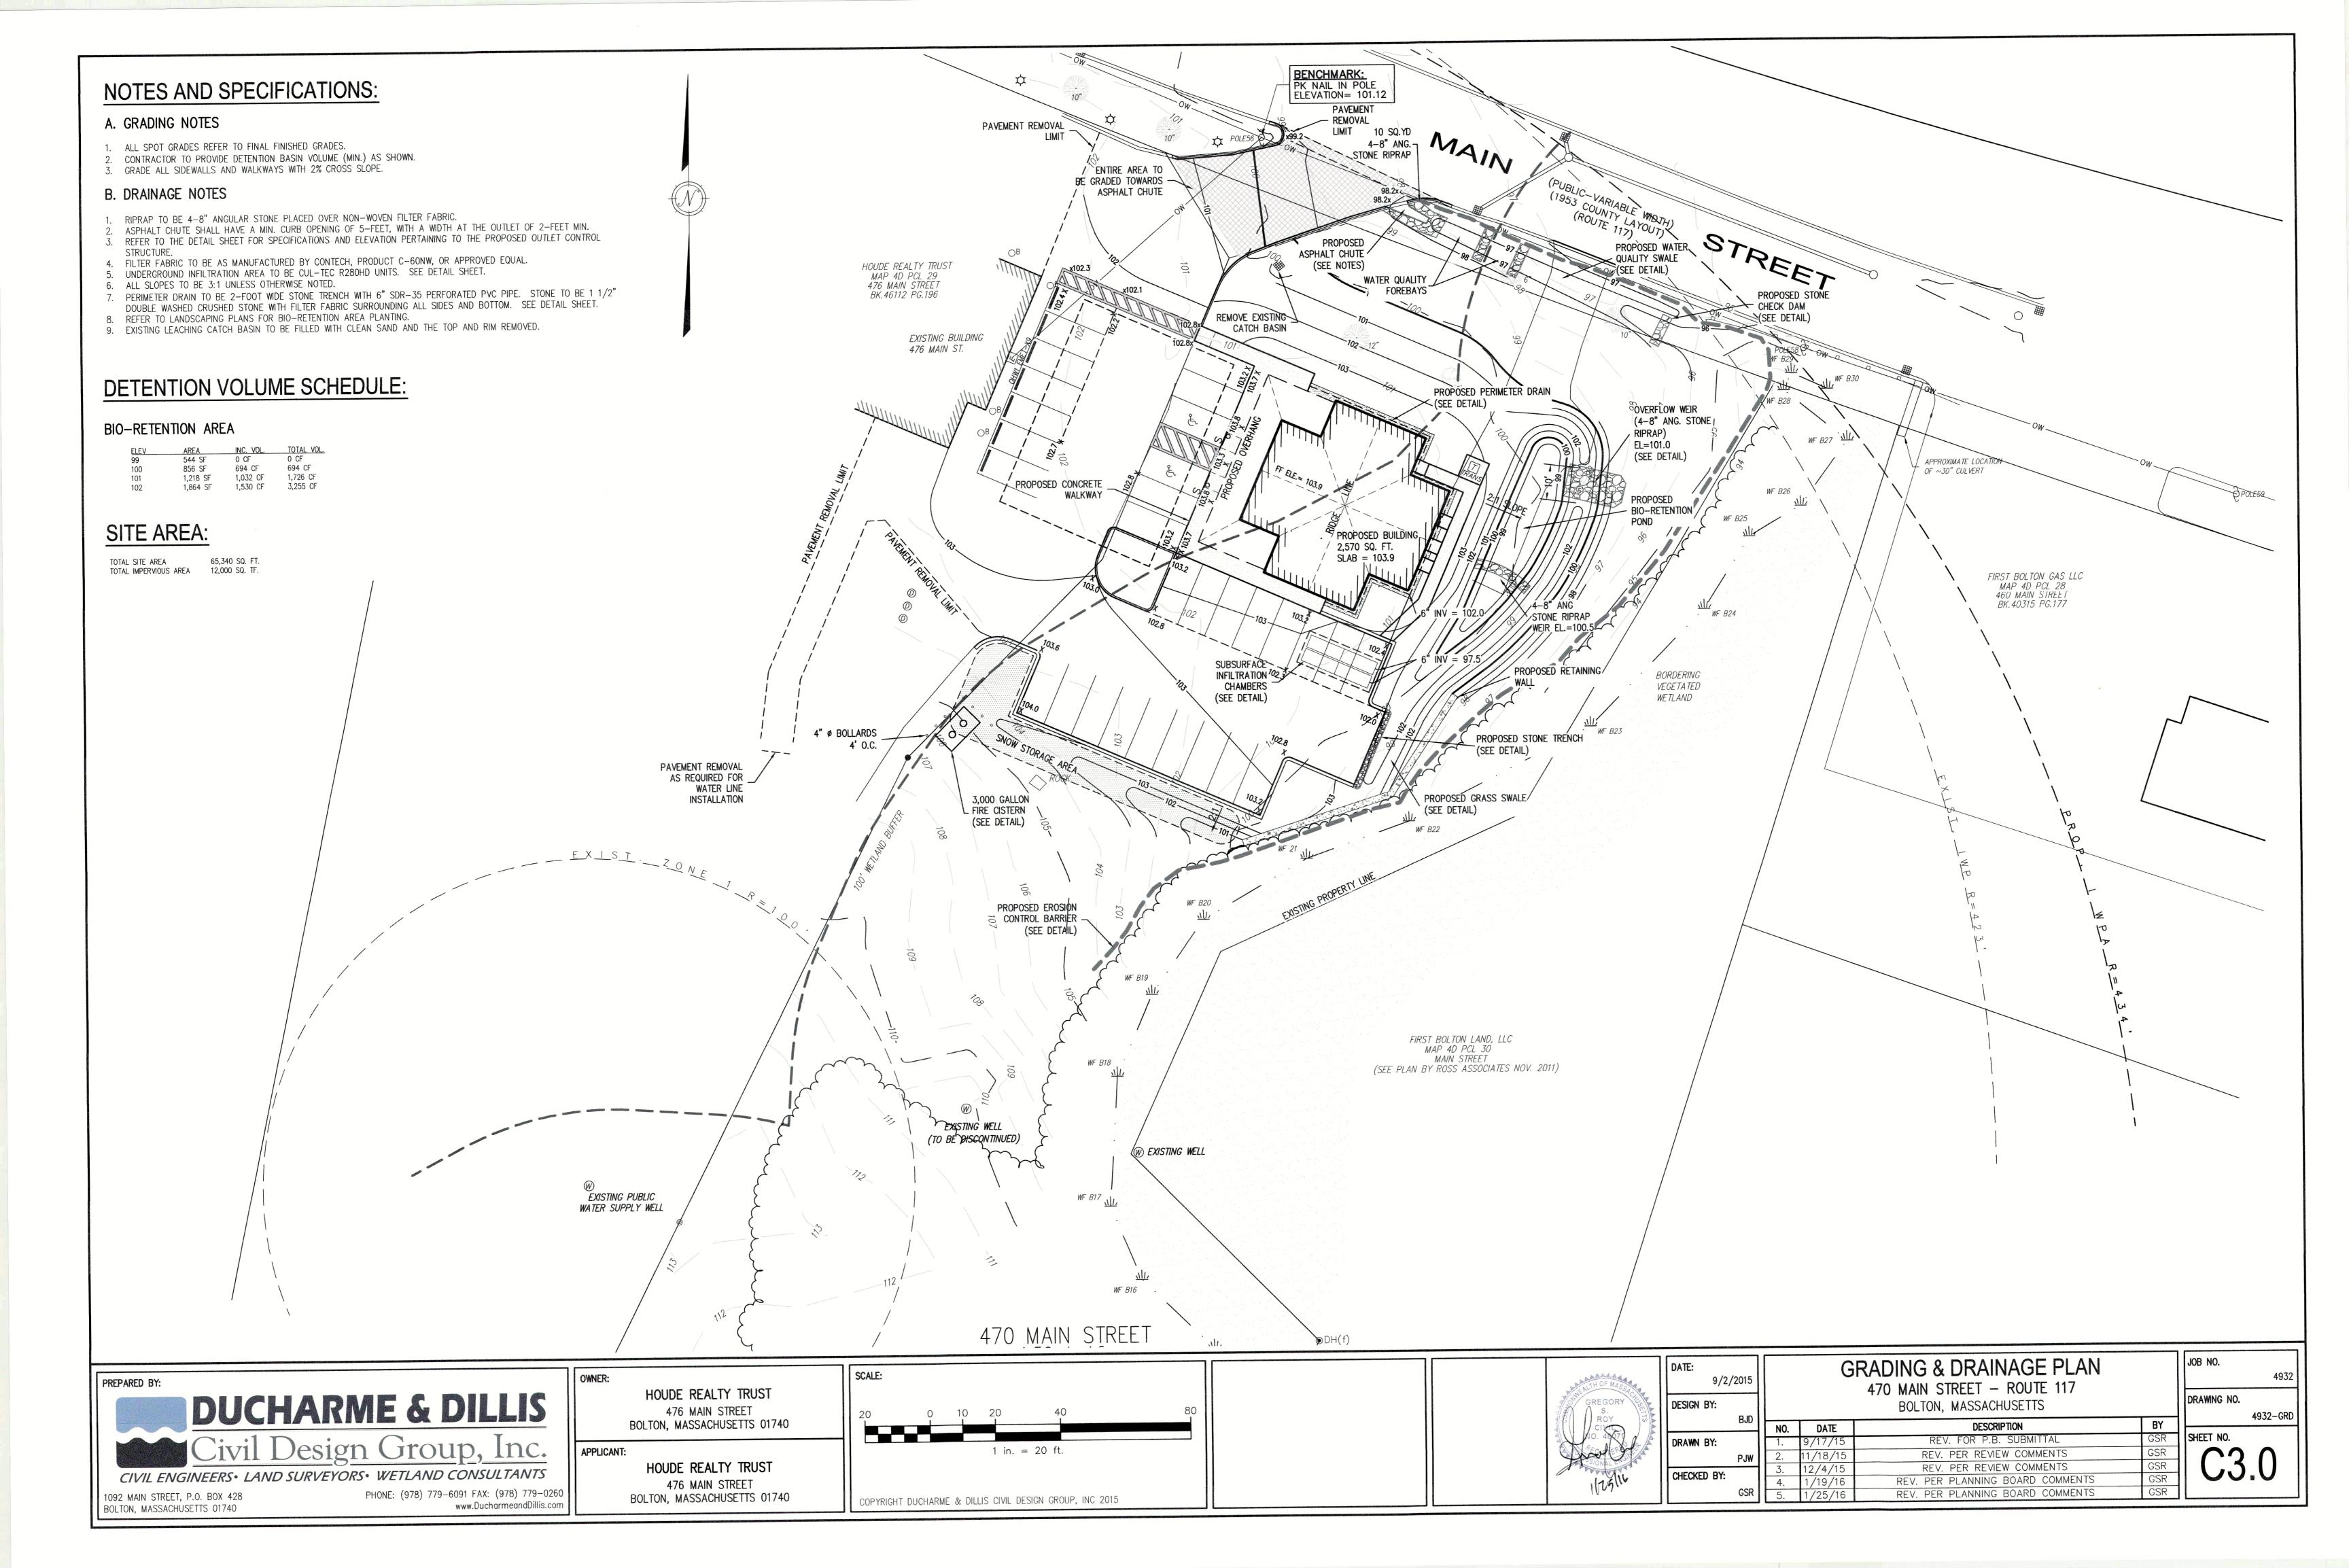


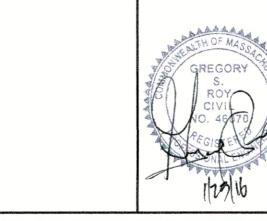



NAME OF THE OWNERS OF THE PARTY		/2015			TITLE SHEET 470 MAIN STREET - ROUTE 117	
	DESIGN BY:	BJD		BOLTON, MASSACHUSETTS		
		טטם	NO.	DATE	DESCRIPTION	BY
۱	DRAWN BY:		1.	9/17/15	REV. FOR P.B. SUBMITTAL	GSR
Ш		PJW	2.	11/18/15	REV. PER REVIEW COMMENTS	GSR
Ш	CHECKED BY:		3.	12/4/15	REV. PER REVIEW COMMENTS	GSR
	OILONED DI.		4.	1/19/16	REV. PER PLANNING BOARD COMMENTS	GSR
Districtions of the last of th		GSR	5.	1/25/16	REV. PER PLANNING BOARD COMMENTS	GSR



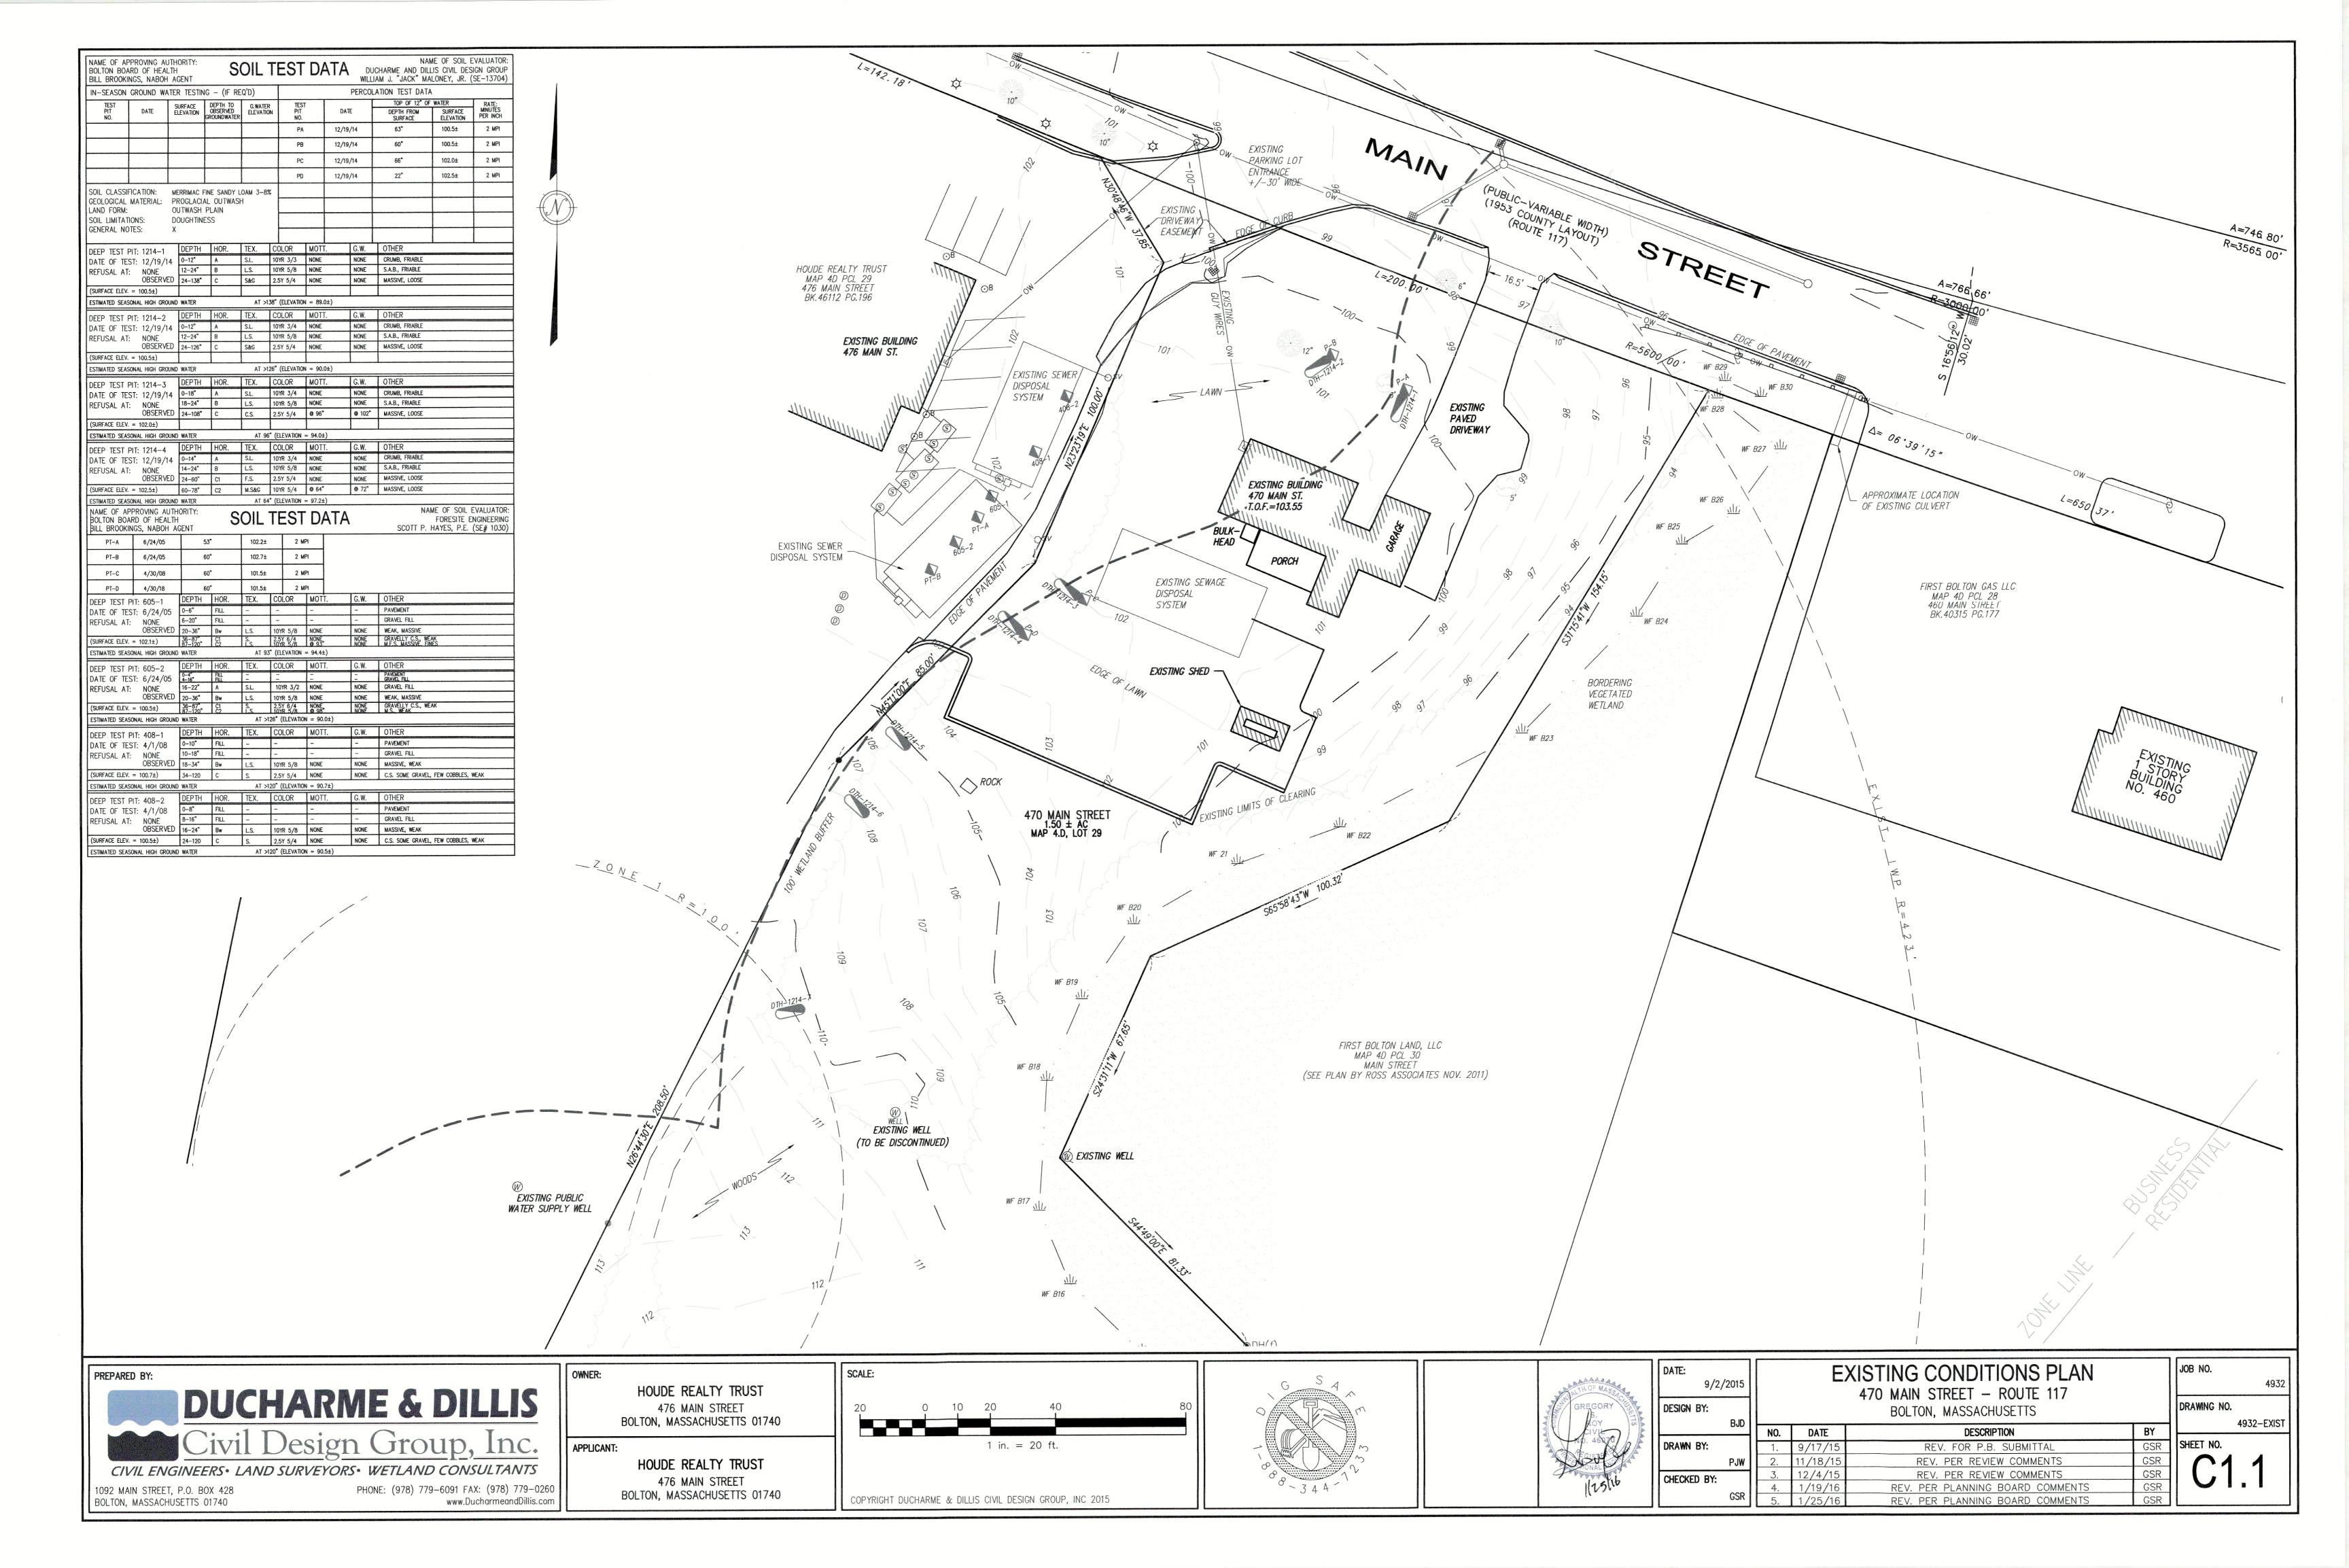

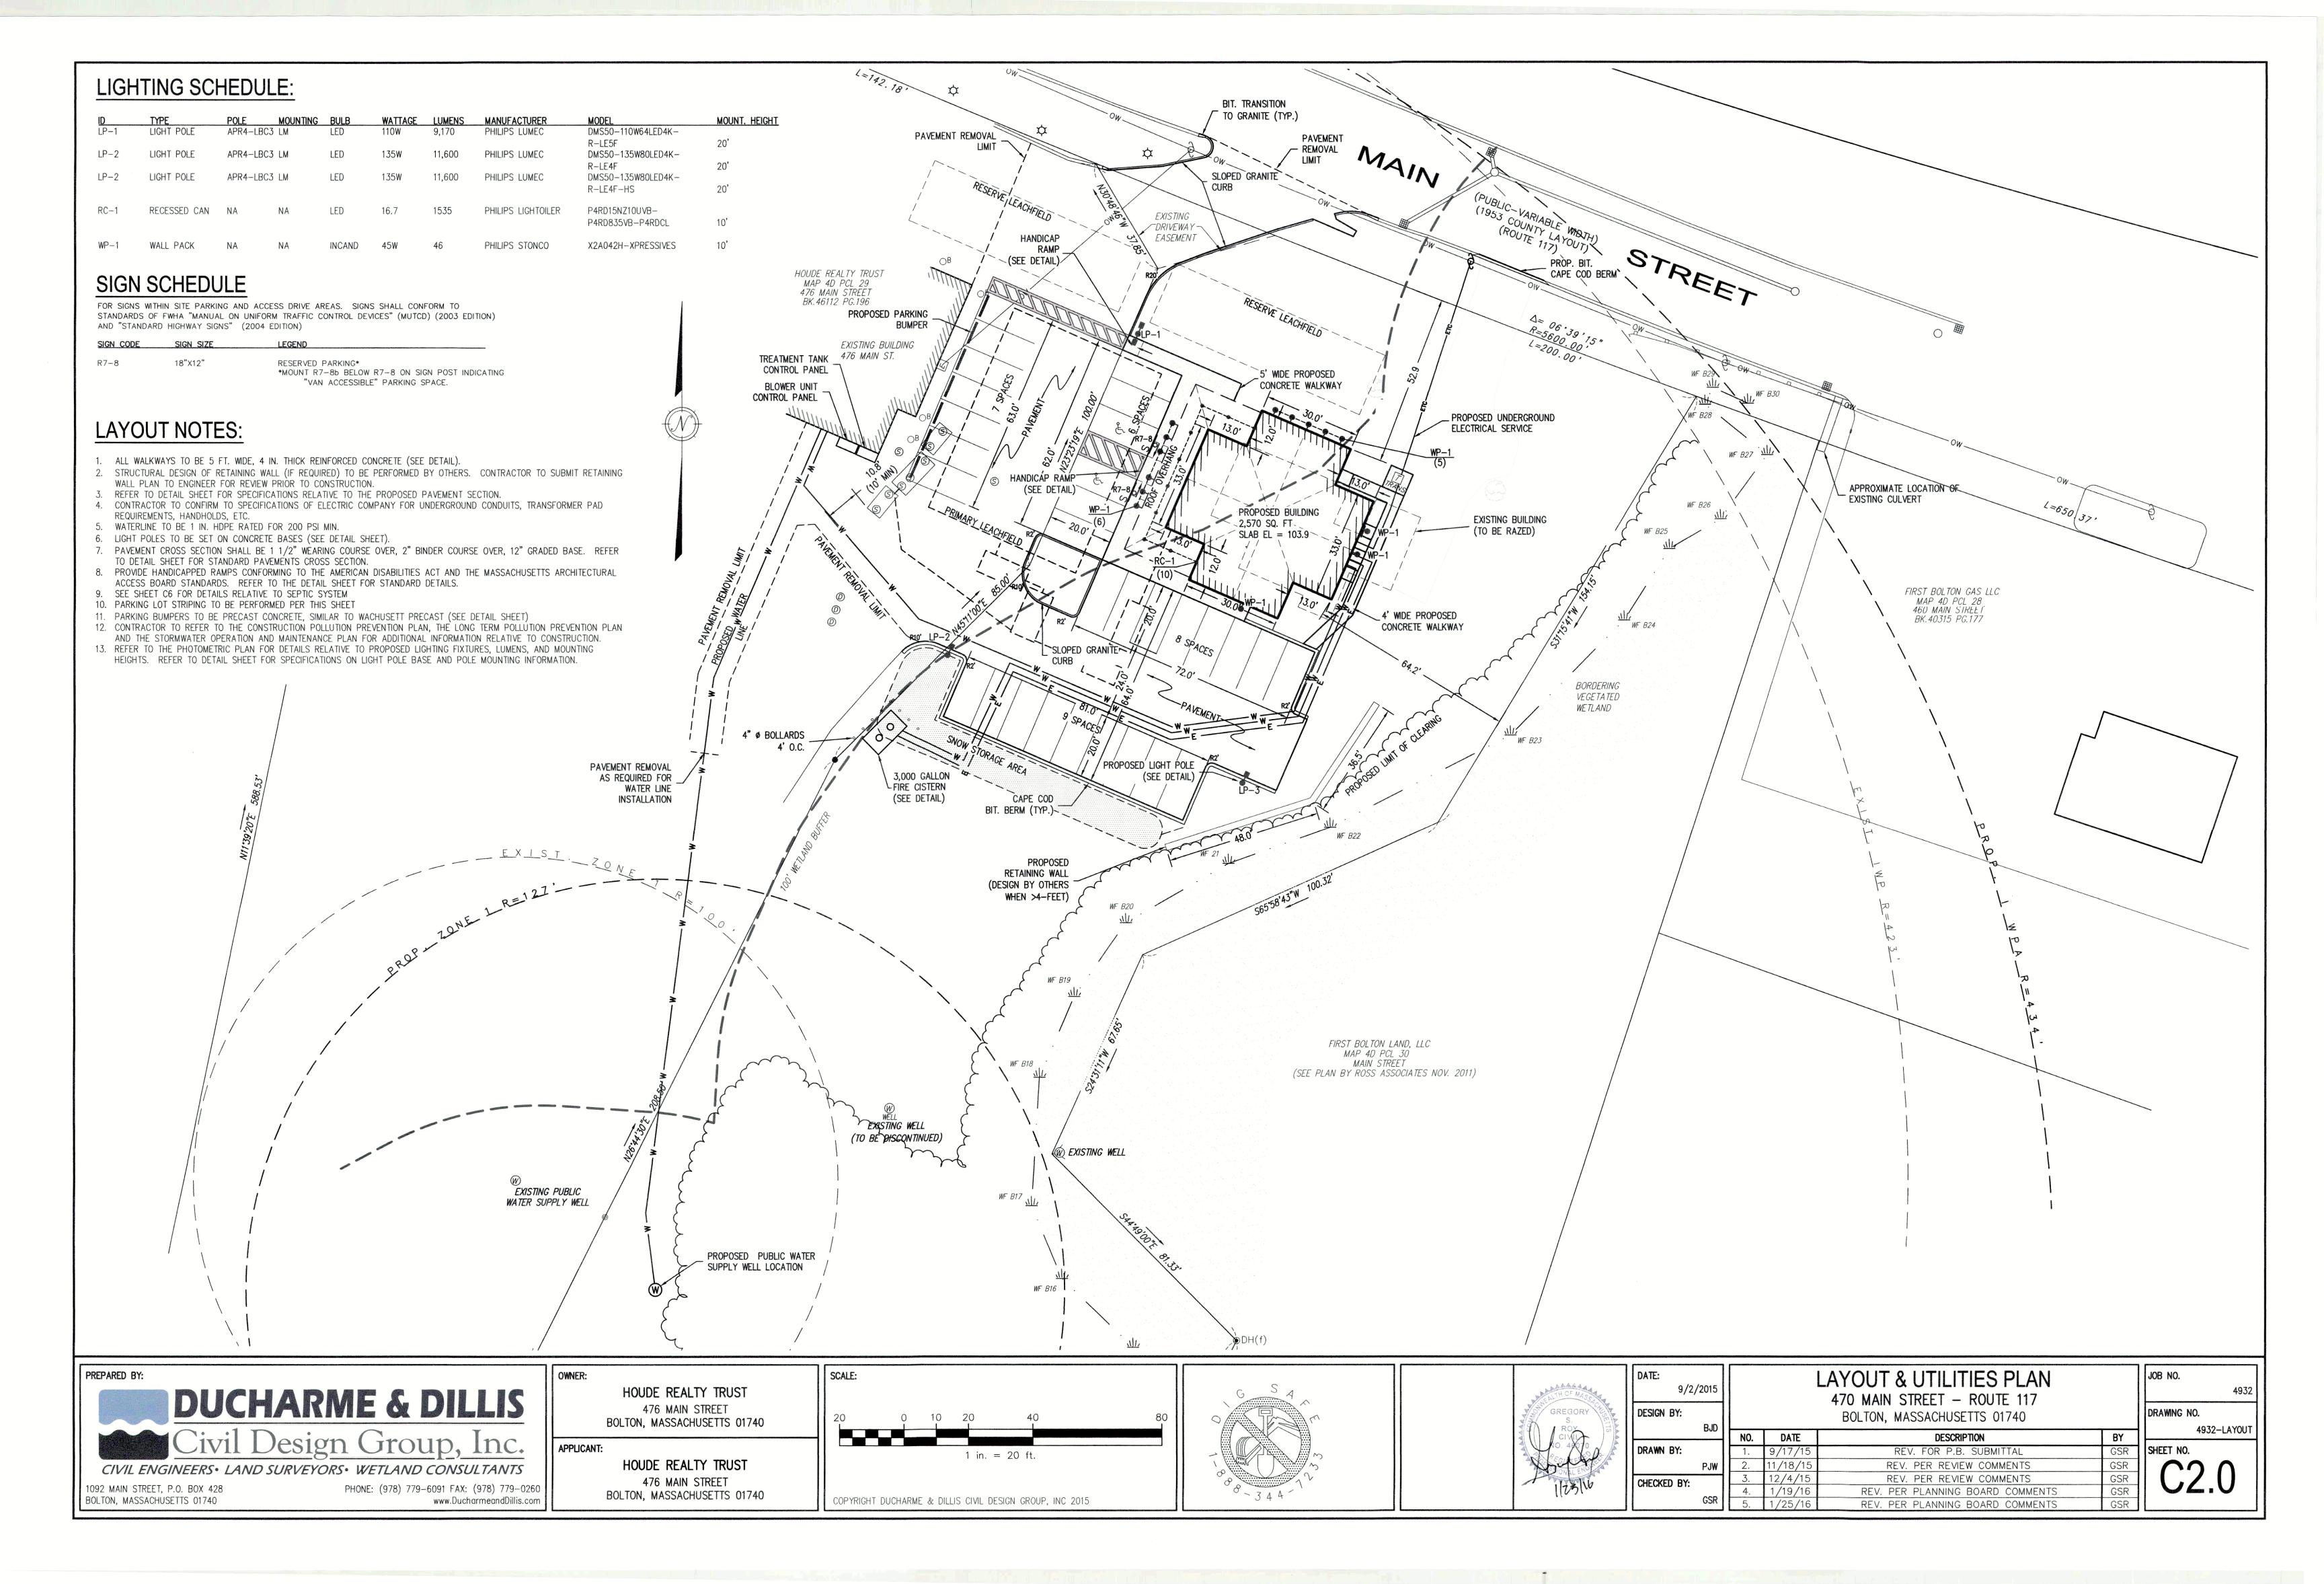


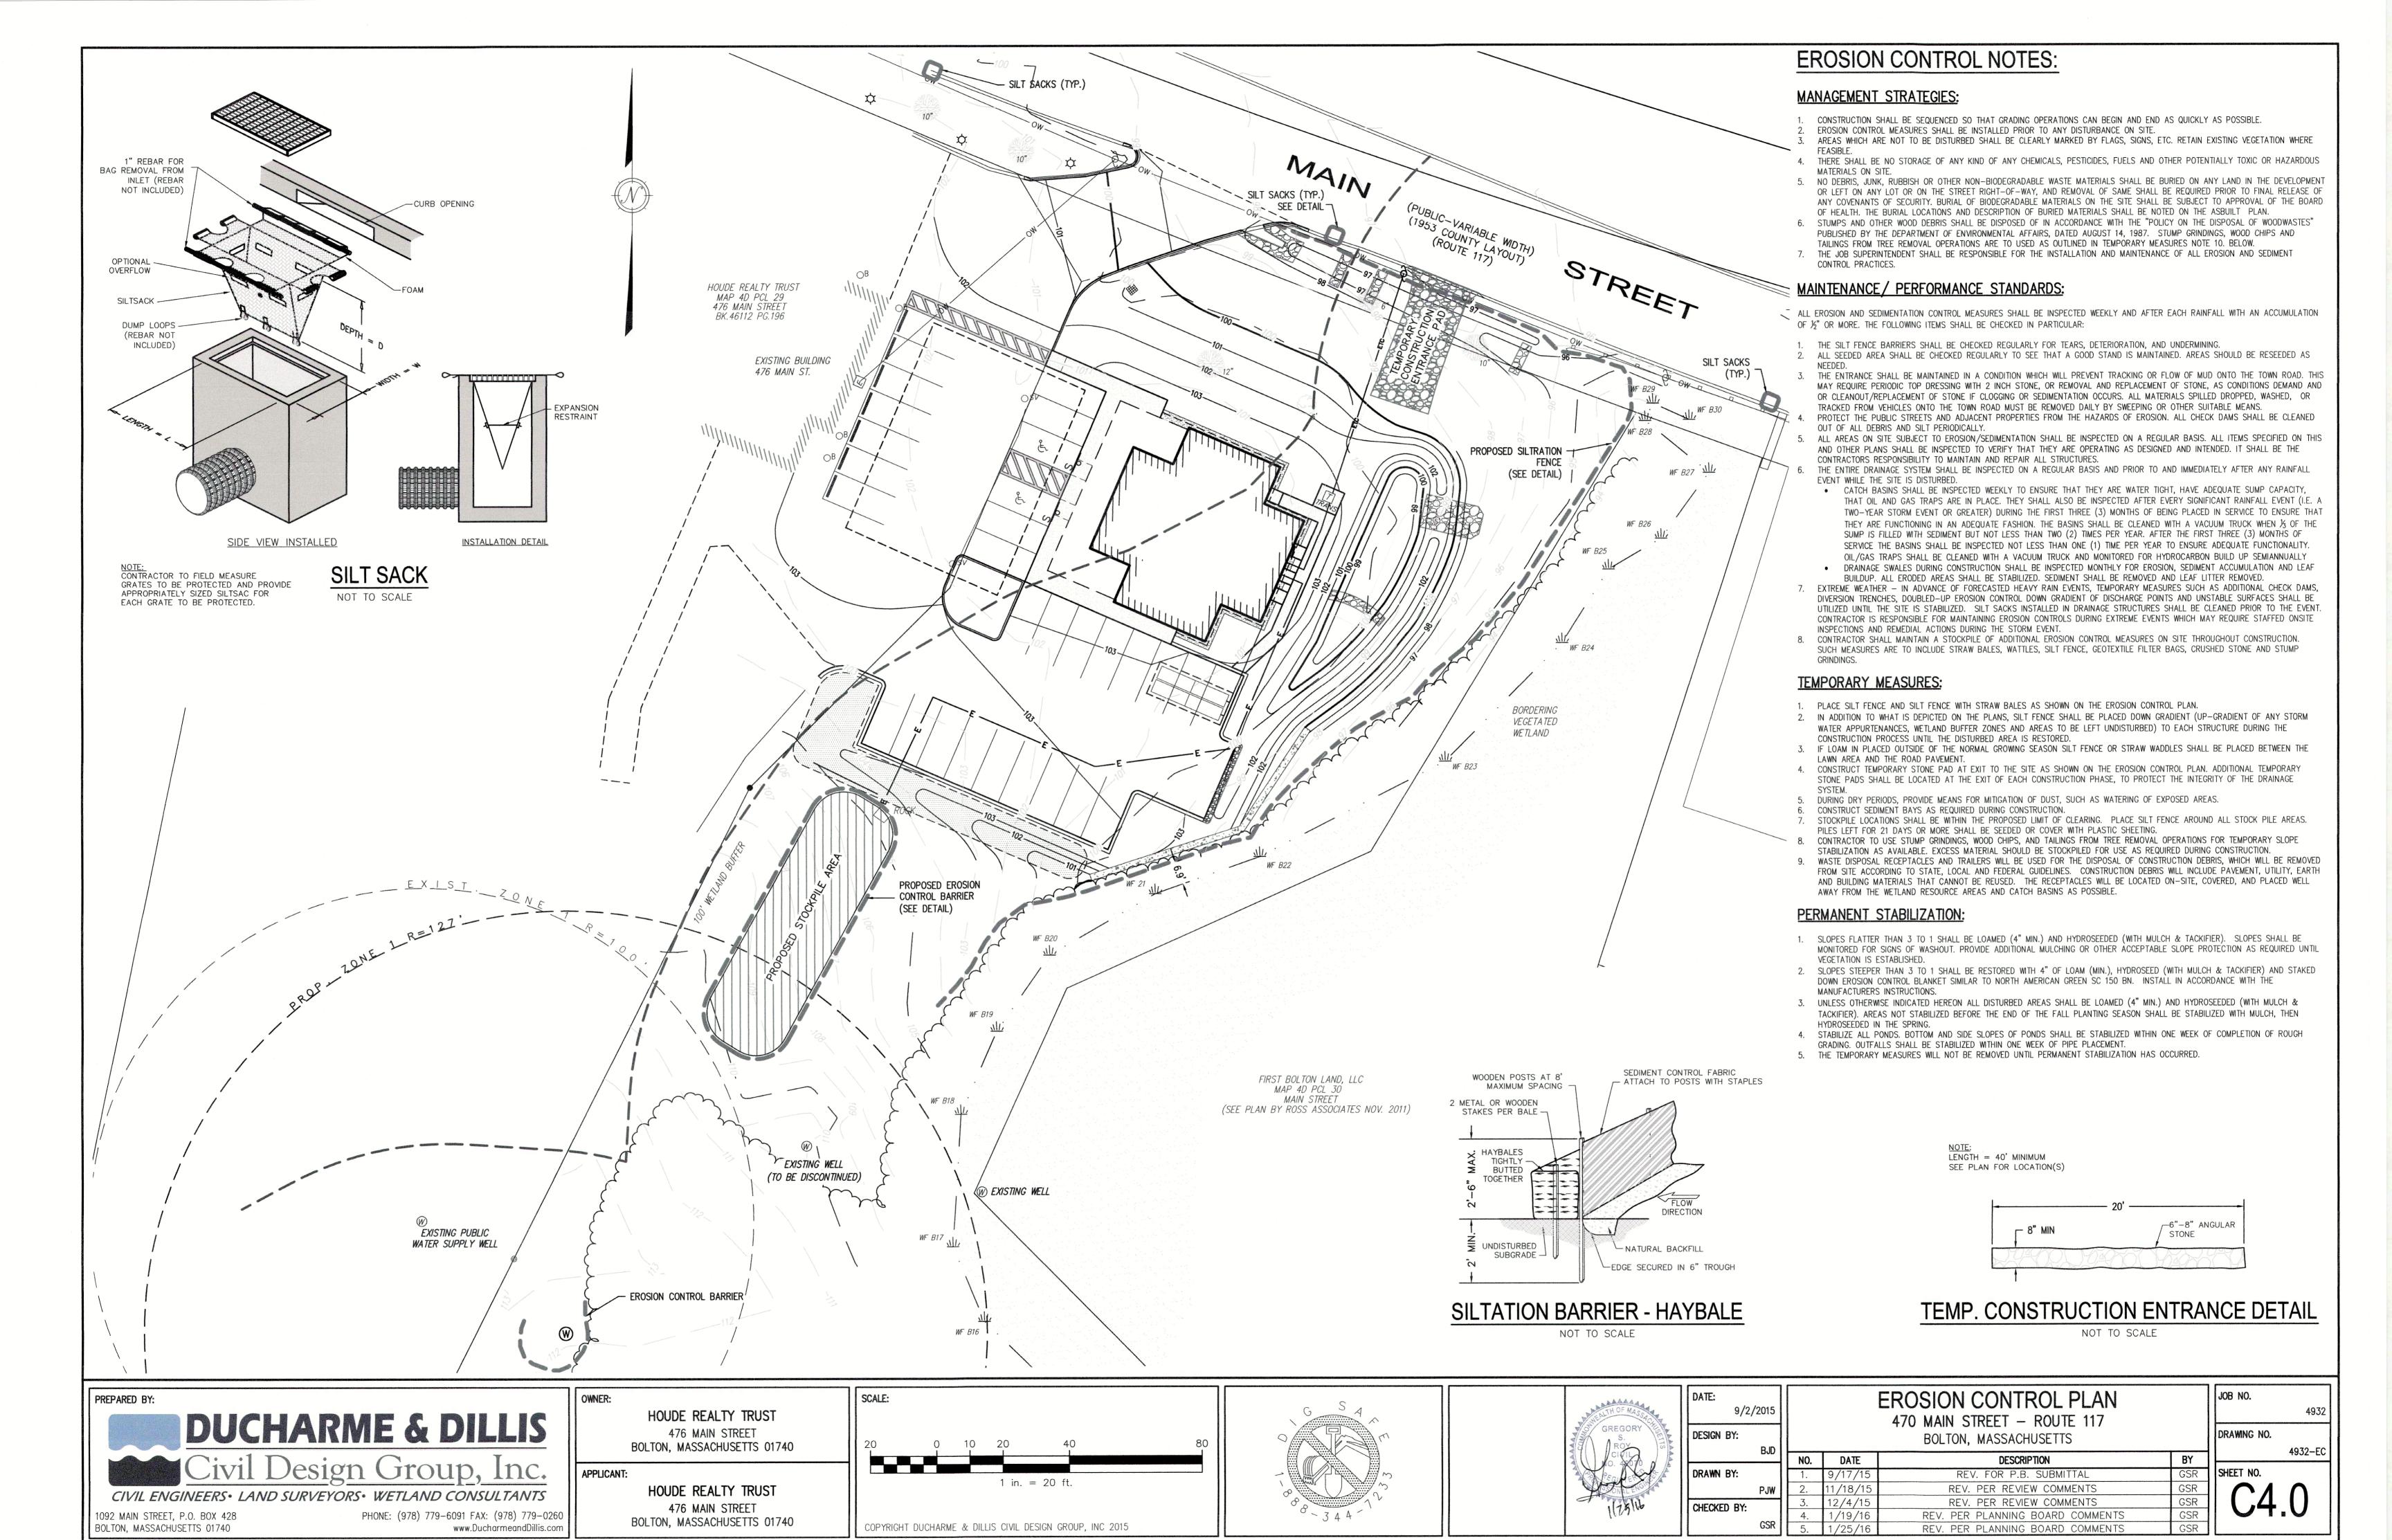

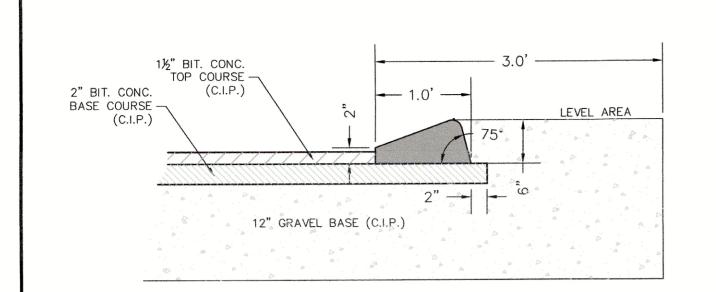


BITUMINOUS CONCRETE CURB DETAIL

NOT TO SCALE

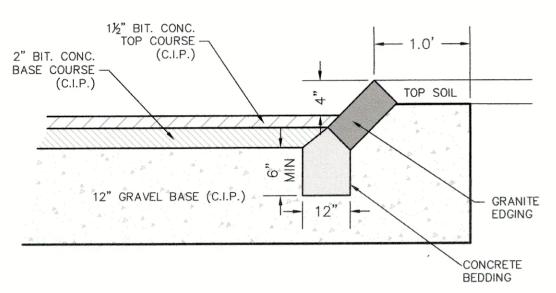

SLOPED GRANITE CURB DETAIL

NOT TO SCALE

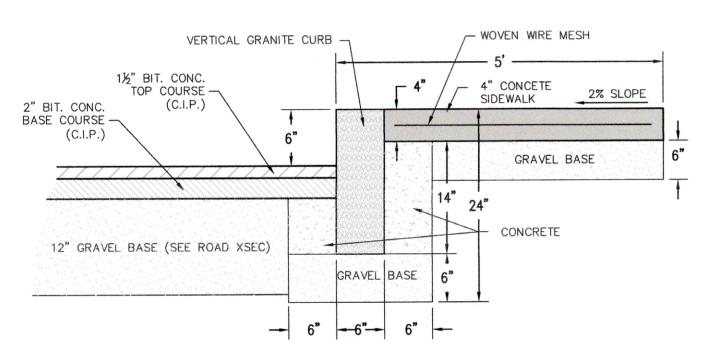


- NOTES:
 1. PLACE JOINTS AT 20 FOOT INTERVALS. ALIGN CURB, GUTTER
- 2. PLACE JOINT FILLER BETWEEN PAVING COMPONENTS AND BUILDING OR OTHER APPURTENANCES WITH A SIKAFLEX-1C
- SL SEALANT OR SIMILAR 3. PROVIDE SCORED JOINTS AT 5 FOOT INTERVALS

AND SIDEWALK JOINTS.


BOLTON, MASSACHUSETTS 01740

CONCRETE SIDWALK DETAIL

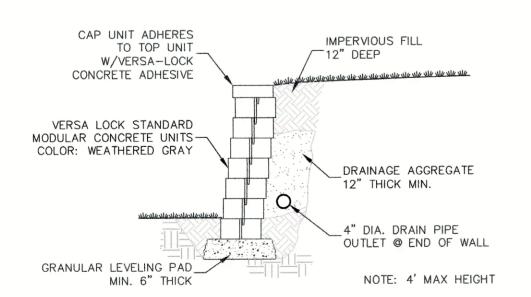


UNREINFORCED RETAINING WALL (<4 FEET)

TYPICAL SECTION NOT TO SCALE

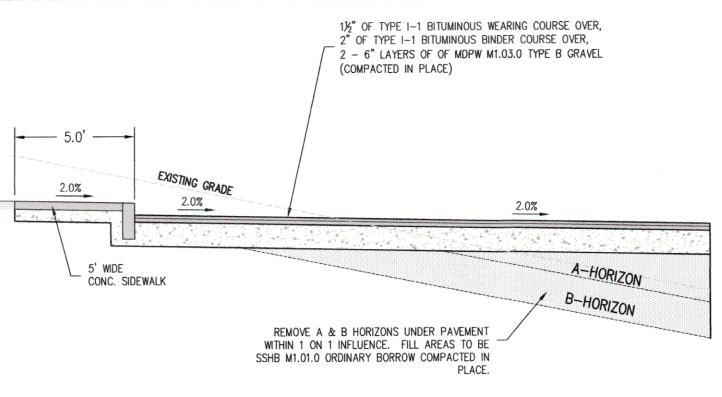

TYPICAL PAVEMENT SECTION

NOT TO SCALE

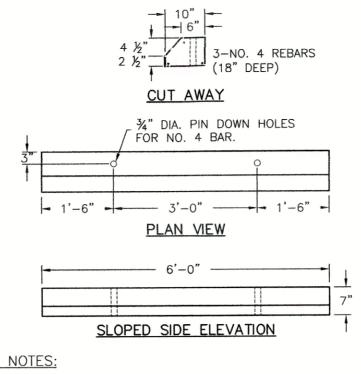

GENERAL NOTES:

- 1. CONCRETE: 28 DAY COMPRESSIVE STRENGTH f'e = 4,000 PSI 2. CEMENT: PORTLAND TYPE III PER
- ASTM C150-81. 3.OLDCASTLE PRECAST OR APPROVED

SINGLE SIDE PARKING BUMPER DETAIL

NOT TO SCALE

BOT. CURB PROFILE VIEW NOTES: 1. REFER TO CURB DETAIL FOR 4" THICK, REINFORCED CONCRETE SIDEWALK SPECIFICATIONS PERTAINING TO INSTALLATION OF CURBING. 2. RAMPS TO BE CONSTRUCTED IN -----ACCORDANCE WITH ADA AND MAAB - 6" GRAVEL BASE 3. DETECTIBLE WARNING TILES TO BE AS SECTION AA MANUFACTURED BY ADA SOLUTIONS, INC. TYP. HANDICAPPED RAMP SCALE: 1"=4"

1:12 MAX

1:12 MAX.

FACE OF CURB

RAMP

11:12 MAX


EMBEDDED DETECTIBLE

WARNING TILE

FLUSH W/PAVE GRADE

SET CURB

PLAN VIEW

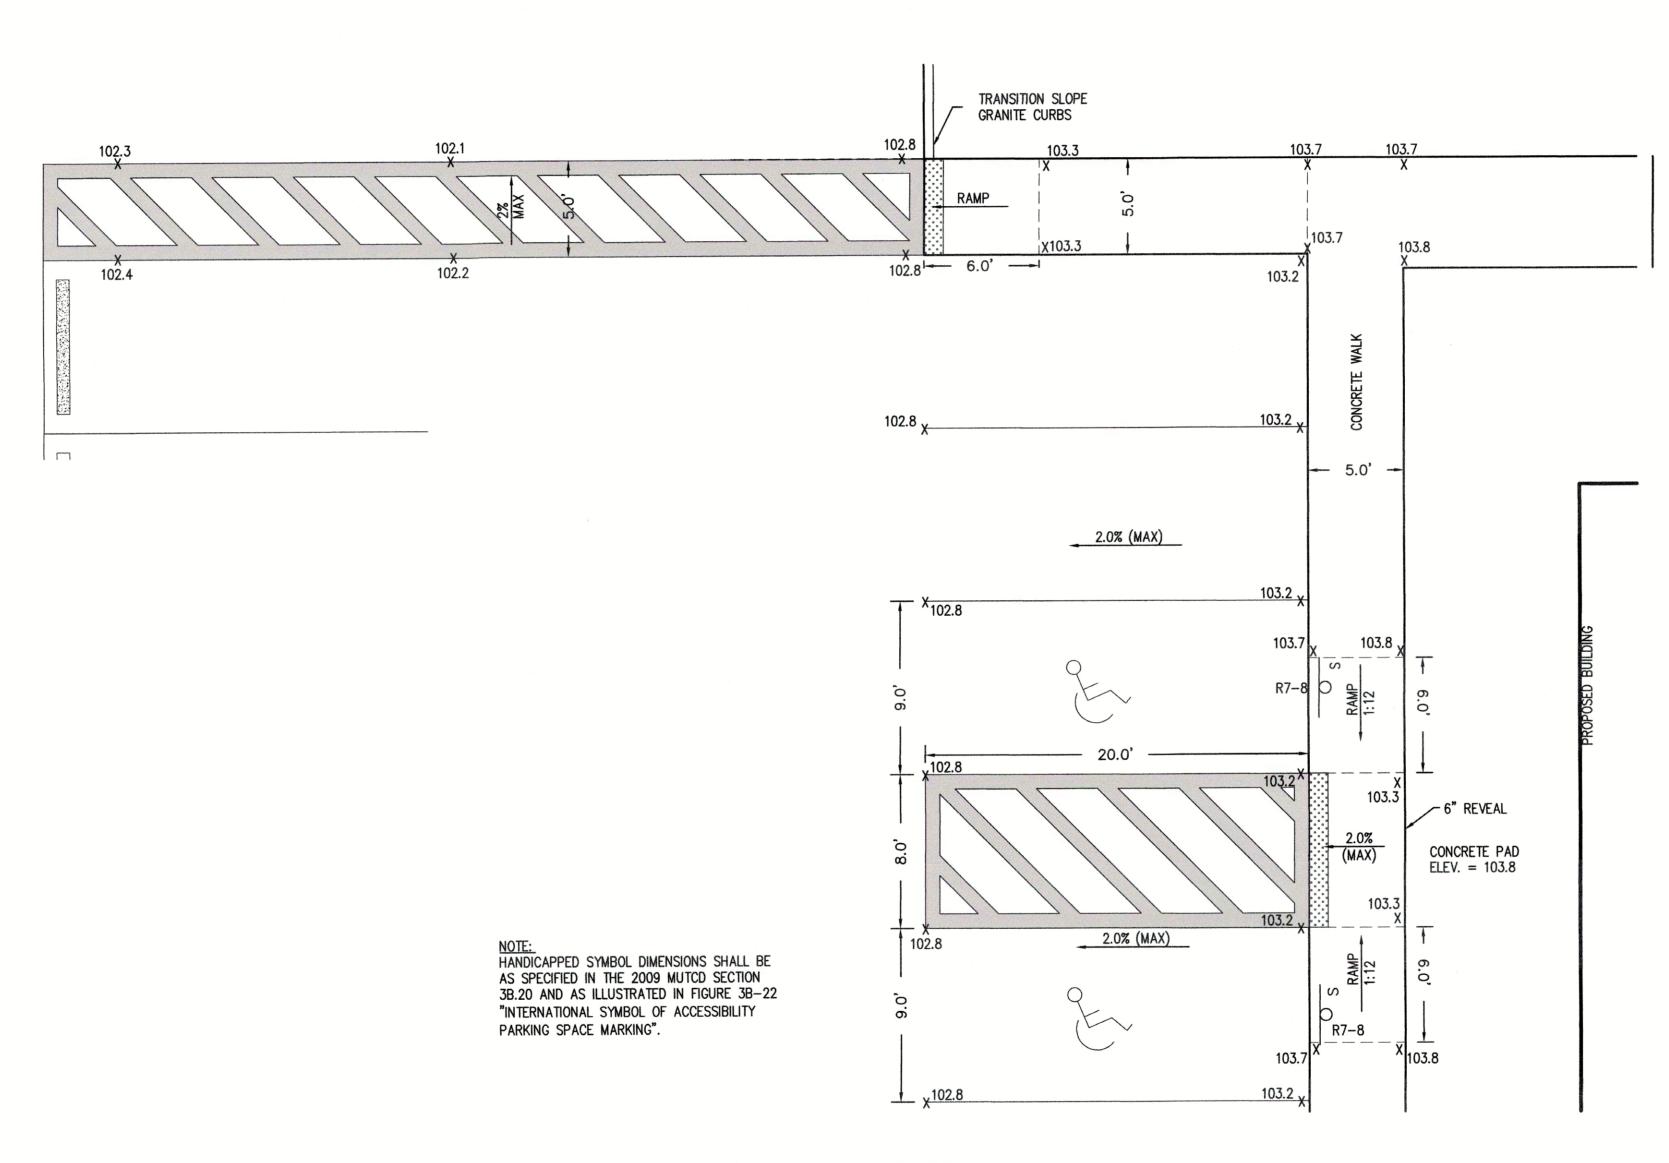

ACCESSIBLE ROUTE DETAIL

PREPARED BY: **DUCHARME & DILLIS** Civil Design Group, Inc.

CIVIL ENGINEERS. LAND SURVEYORS. WETLAND CONSULTANTS 092 MAIN STREET, P.O. BOX 428 PHONE: (978) 779-6091 FAX: (978) 779-0260

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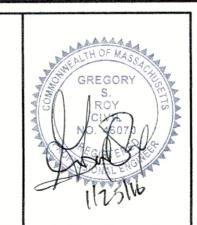
HOUDE TRUST REALTY TRUST 476 MAIN STREET BOLTON, MASSACHUSETTS

APPLICANT:

HOUDE REALTY TRUST 476 MAIN STREET BOLTON, MASSACHUSETTS SCALE:


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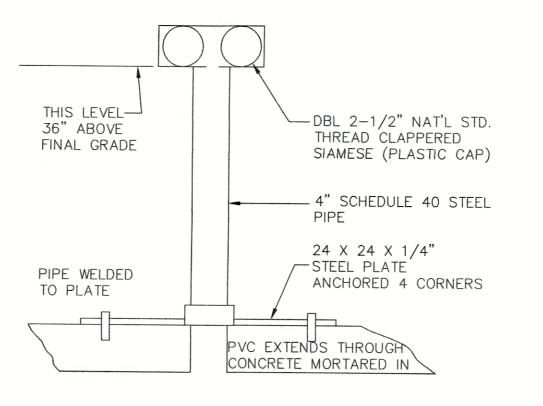





DATE: 9/2/	/2015			DETAIL SHEET 470 MAIN STREET - ROUTE 117
DESIGN BY:				BOLTON, MASSACHUSETTS
	BUD	NO.	DATE	DESCRIPTION
DRAWN BY:		1.	9/17/15	REV. FOR P.B. SUBMITTAL
	PJW	2.	11/18/15	REV. PER REVIEW COMMENTS
CHECKED BY:		3.	12/4/15	REV. PER REVIEW COMMENTS
CHECKED BI.		4.	1/19/16	REV. PER PLANNING BOARD COMMENTS
	GSR	5.	1/25/16	REV. PER PLANNING BOARD COMMENTS

Control Marie	JOB NO.	
	4932	
	DRAWNG NO.	
1	4932-DETAIL	
1	SHEET NO.	
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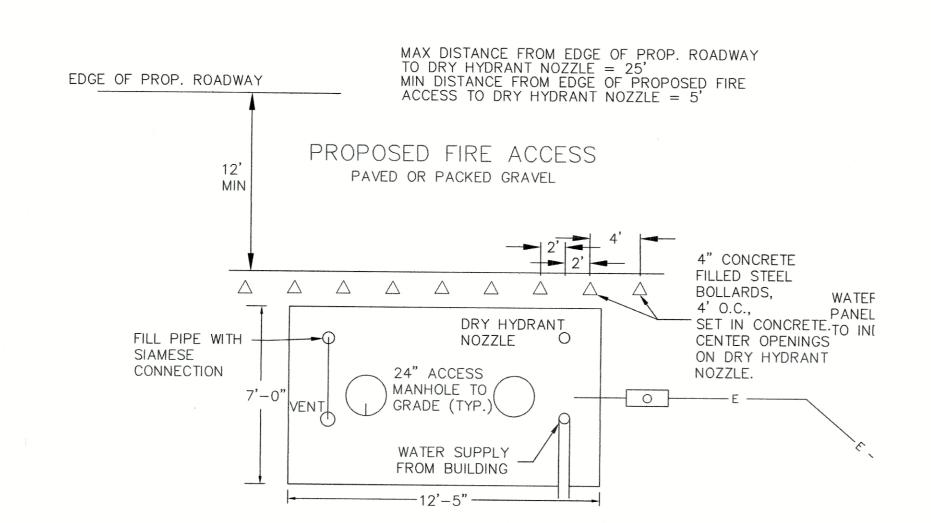
CISTERN FILL PIPE

NOT TO SCALE

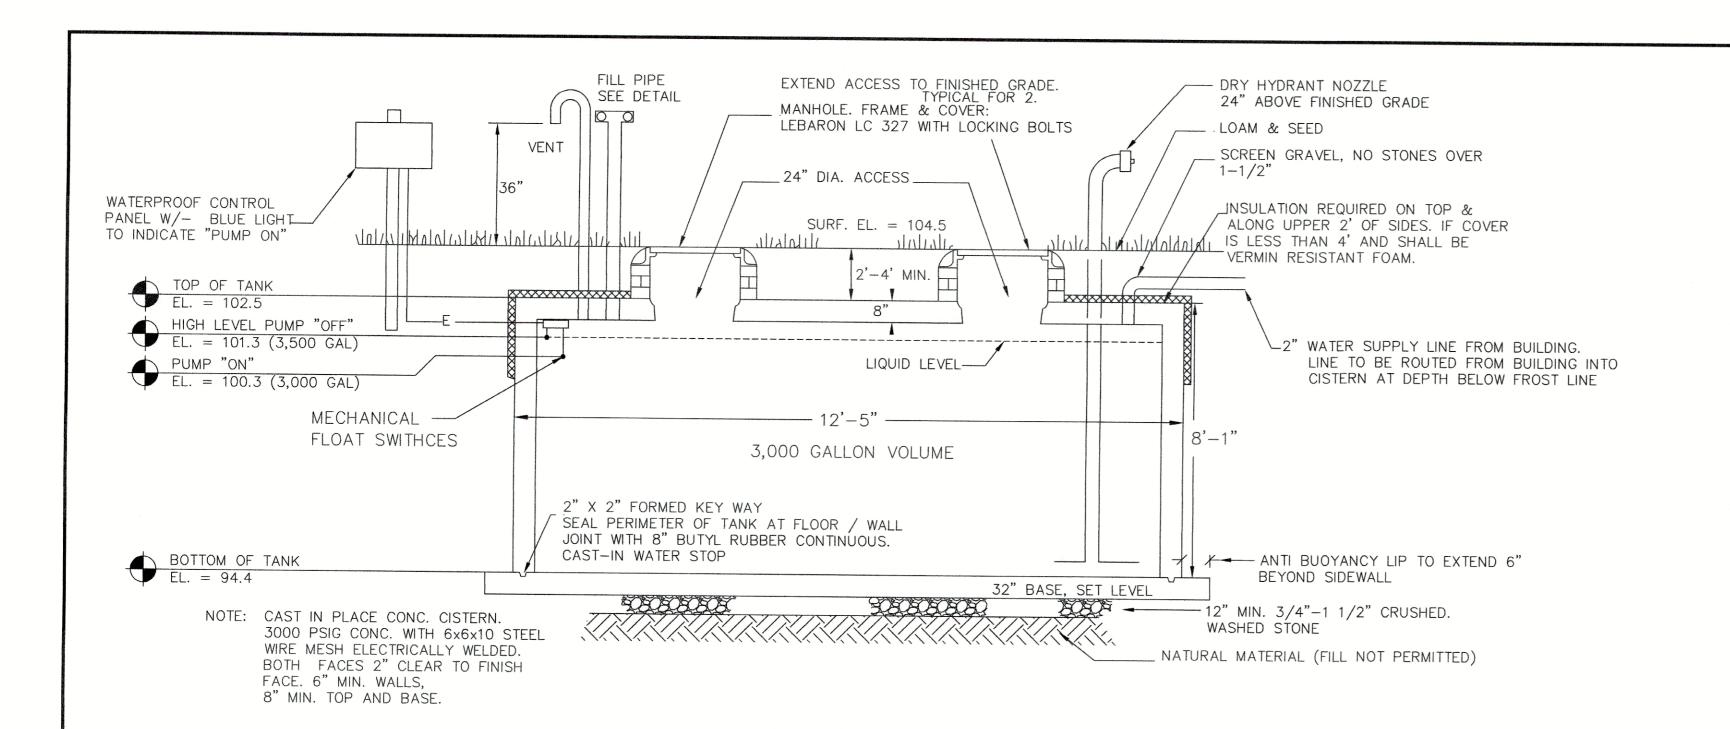CISTERN LOWER SUCTION PIPE NOT TO SCALE

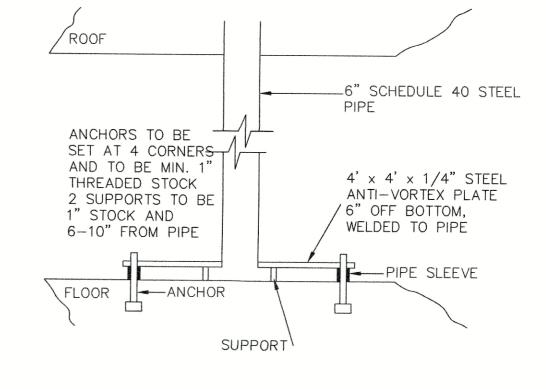
3,000 GALLON FIRE CISTERN PROFILE

NOT TO SCALE




FIRE CISTERN PLAN VIEW


NOT TO SCALE

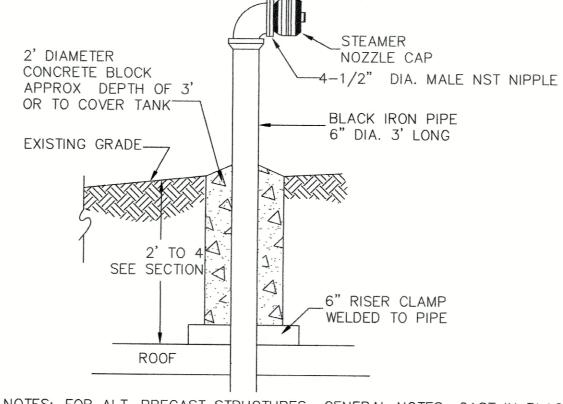

INSTALL CAST-IN HIGH DENSITY POLYURETHANE STEPS 18" O.C., MIN. 4 (OUTLET SIDE ONLY) PRECAST STEEL REINFORCED CHAMBER CAPABLE OF DIRECT AASHTO HS-20-44 LOADING SUBJECT TO THE APPROVAL OF THE DESIGN EQUAL TO ROTONDO LWT 8x10-23 W/ BAFFLE WITH INTERIOR BAFFLES, SUBMIT SHOP DRAWING OF TANK AND ALL CONNECTIONS

MORTAR ALL JOINTS & CONNECTIONS WATERTIGHT PROVIDE FLEXIBLE PIPE JOINT WITHIN 4'. ALL JOINTS, CHAMBER AND MATERIALS TO BE WATERTIGHT ONCE CONSTRUCTED & IN PLACE. FOR APPROVAL

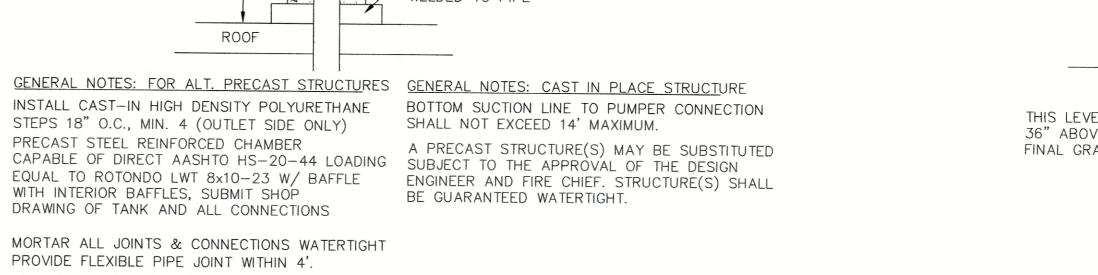

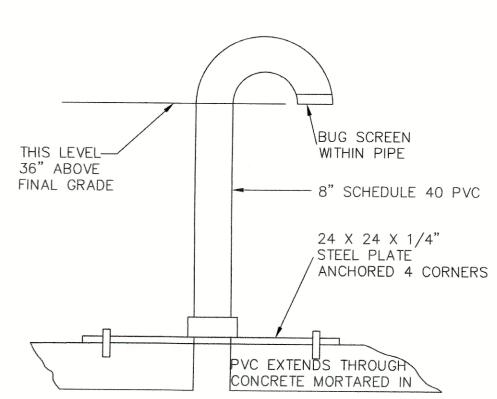

CISTERN DRY HYDRANT DETAIL

CISTERN VENT PIPE NOT TO SCALE

NOT TO SCALE

PREPARED BY:	
	DUCHARME & DILLIS
	Civil Design Group, Inc.


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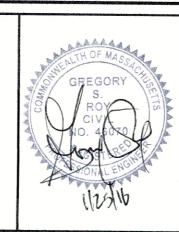
HOUDE TRUST REALTY TRUST 476 MAIN STREET BOLTON, MASSACHUSETTS

SCALE:

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APPLICANT: HOUDE REALTY TRUST 476 MAIN STREET BOLTON, MASSACHUSETTS



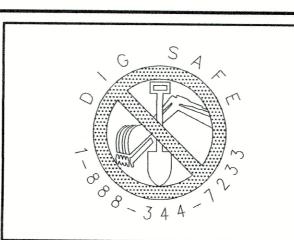

	Santa s
	DATE:
STTS XXXXXXXXXXXXXXXXXXXXXXXXXXXXXXXXXX	DESIGN
	DRAWN
16	CHECKE

	-
DATE:	
9/2/2015	-
DESIGN BY:	BIOLOGICA CONTRACTOR C
BJD	
	NO
DRAWN BY:	1.
PJW	2.
	7

		DETAIL SHEET 470 MAIN STREET - ROUTE 117 BOLTON, MASSACHUSETTS
NO	DATE.	7
NO.	DATE	DESCRIPTION
1.	9/17/15	REV. FOR P.B. SUBMITTAL
2.	11/18/15	REV. PER REVIEW COMMENTS


REV. PER REVIEW COMMENTS


REV. PER PLANNING BOARD COMMENTS

REV. PER PLANNING BOARD COMMENTS

JOB NO.
4932
DRAWNG NO.
4932-DETAIL
SHEET NO.
C5 1

GSR

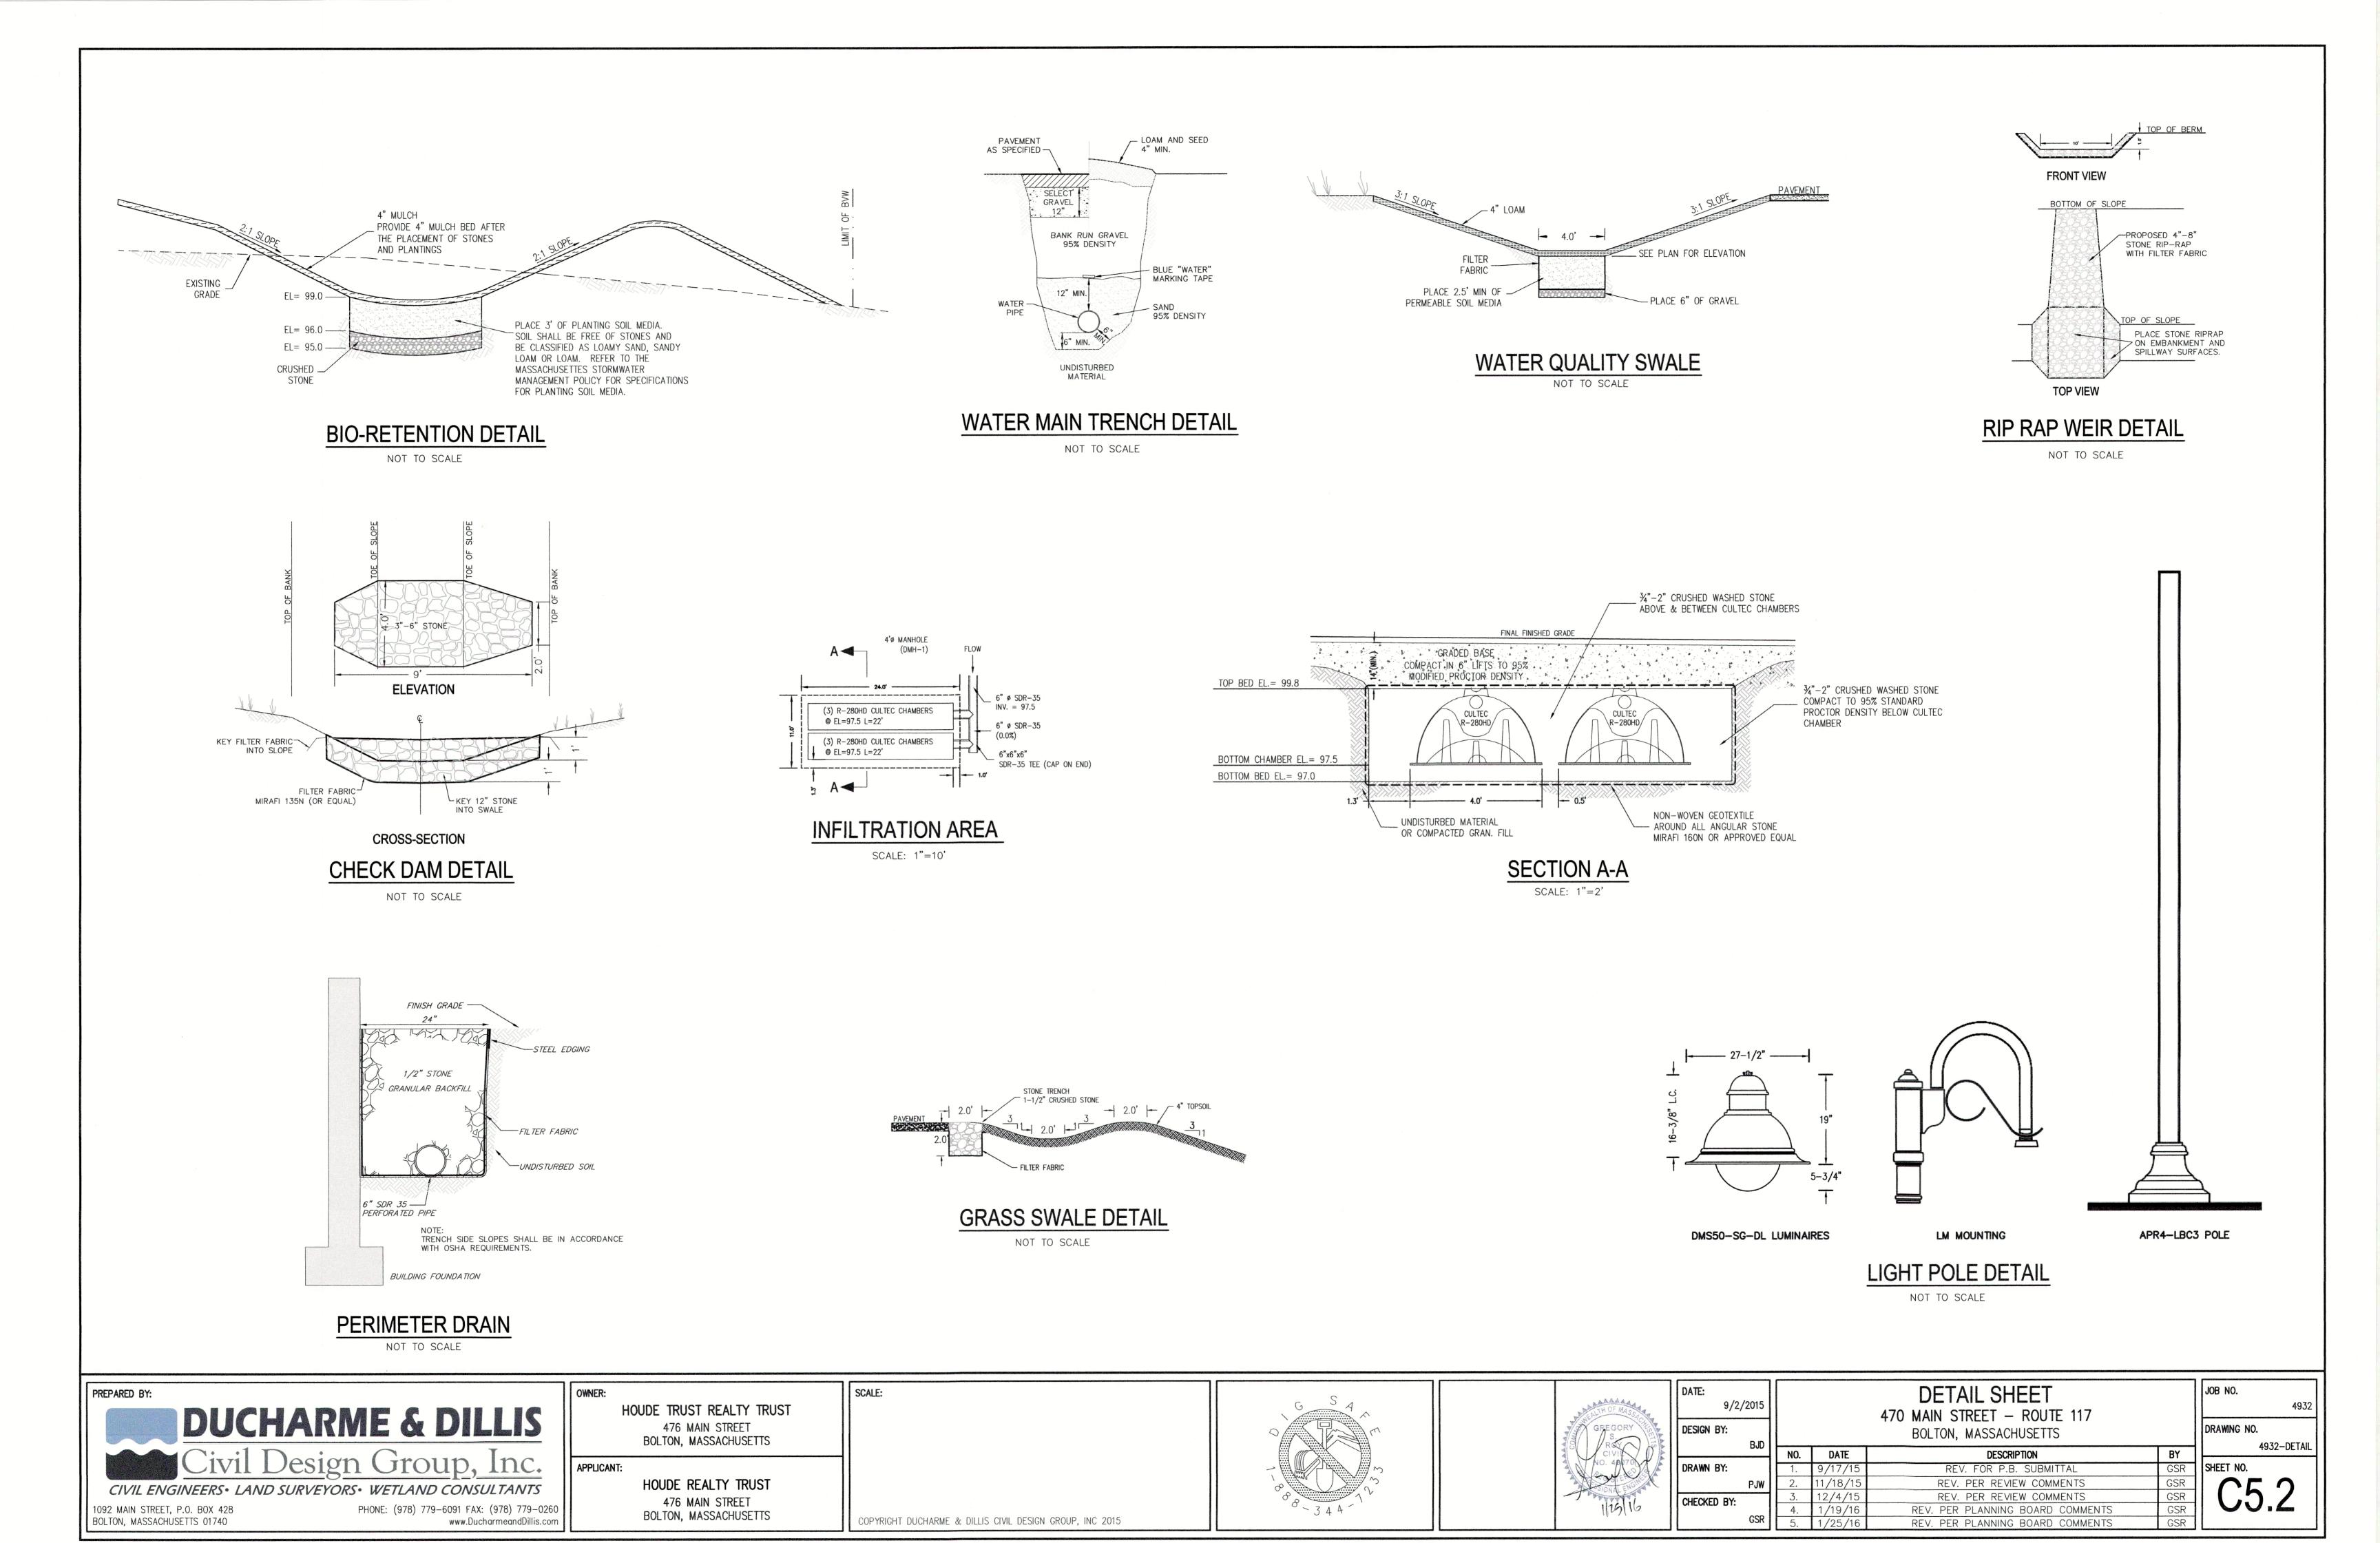

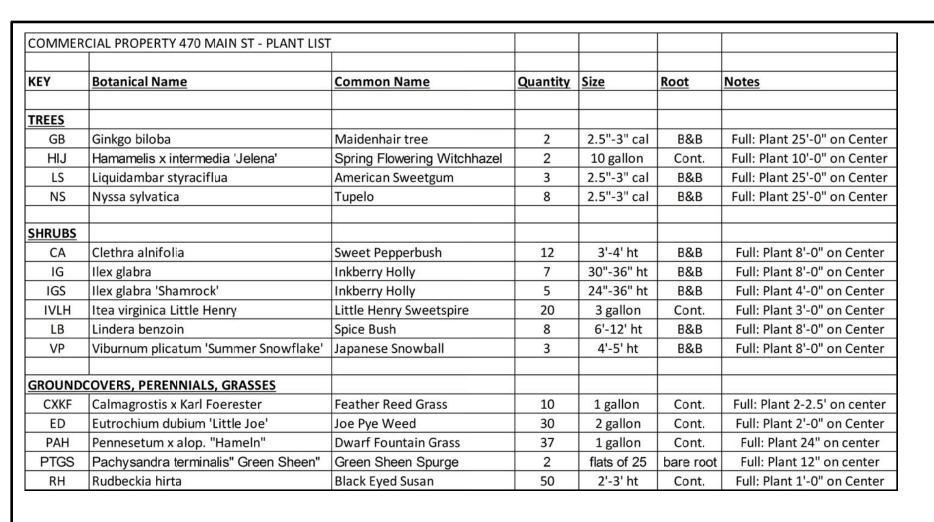

PLANTING NOTES

- . REFER TO CIVIL ENGINEERS UTILITY, GRADING AND DRAINAGE PLANS FOR UTILITY LOCATIONS AND DRAINAGE
- 2. REFER TO CIVIL ENGINEERS GRADING PLANS FOR GRADING INFORMATION. IF ACTUAL SITE CONDITIONS VARY
- 3. VERIFY LOCATIONS OF ALL SITE IMPROVEMENTS INSTALLED. IF ANY PART OF THIS PLAN CANNOT BE IMPLEMENTED DUE TO SITE CONDITIONS, CONTACT THE LANDSCAPE ARCHITECT PRIOR TO COMMENCING WORK. 4. CONTACT CALL BEFORE YOU DIG TO CONFIRM ALL UTILITY LOCATIONS BEFORE COMMENCING ANY WORK 5. PERFORM EXCAVATION FOR LANDSCAPE WORK IN THE VICINITY OF UNDERGROUND UTILITIES WITH CARE, AND IF NECESSARY, BY HAND. CONTRACTOR BEARS FULL RESPONSIBILITY FOR THIS WORK AND DISRUPTION OR
- 6. CONTRACTOR TO VERIFY PLANT COUNTS AND SQUARE FOOTAGES. QUANTITIES ARE PROVIDED AS OWNER INFORMATION ONLY. IF QUANTITIES ON PLANT LIST DIFFER FROM GRAPHIC INDICATIONS, THEN GRAPHIC INDICATIONS SHALL PREVAIL.

DAMAGE TO UTILITIES SHALL BE REPAIRED IMMEDIATELY AT NO EXPENSE TO THE OWNER.

- 7. ALL DISTURBED AREAS NOT COVERED BY STRUCTURES, PAVEMENT, RIP RAP, STONE, MULCH OR PLANTING BEDS AND TREE PITS SHALL BE TOP SOILED AND SEEDED.
- 8. CONTRACTOR SHALL BE RESPONSIBLE FOR TESTING ALL TOPSOIL IN ACCORDANCE WITH THE SPECIFICATIONS AND PROVIDING TEST RESULTS TO THE LANDSCAPE ARCHITECT PRIOR TO PLACING TOPSOIL.
- 9. ALL AREAS TO RECEIVE SEED SHALL BE PREPARED BY: A) REMOVING ALL STONES, PAVEMENTS, GRAVEL, ETC.; B) SCARIFYING EXISTING SUB GRADE; C) PLACING 6" MINIMUM TESTED AND APPROVED TOPSOIL; D) PROVIDING ANY SOIL AMENDMENTS AS SPECIFIED, AND REQUIRED BY SOIL TEST.
- O. LANDSCAPE ARCHITECT SHALL REVIEW PLANT MATERIALS AT SOURCE OR BY PHOTOGRAPHS PRIOR TO DELIVERY TO SITE. THE LANDSCAPE ARCHITECT RESERVES THE RIGHT TO REJECT ANY AND ALL PLANT MATERIAL WHEN DELIVERED TO THE SITE. THE CONTRACTOR SHALL RECEIVE LANDSCAPE ARCHITECT'S APPROVAL OF PLANT MATERIAL QUALITY AND LOCATION PRIOR TO INSTALLATION.
- I. FINAL LOCATION OF PLANTING TO BE VERIFIED IN THE FIELD BY THE LANDSCAPE ARCHITECT BEFORE DIGGING. CONTRACTOR SHALL STAKE OUT ALL PLANTING BEDS AND FLAG ALL TREES AND EACH INDIVIDUAL SHRUB PRIOR TO UNLOADING PLANTS FROM TRUCK. SPADE EDGE ALL PLANTING BEDS IN LAWN AREAS.
- 13. PLANTING MIX BACKFILL FOR PLANT HOLES TO BE 2 PARTS LOAM/TOPSOIL TO 1 PART COW MANURE OR 2 PARTS ORGANIC COMPOST TO 1 PART PEAT MOSS. PLANT MIX BACKFILL FOR BEARBERRY AND ORNAMENTAL GRASSES TO BE I PART LOAM TO I PART SAND TO ONE PART ORGANIC COMPOST.

12. SPADE EDGE ALL PLANTING BEDS IN LAWN AREAS.

Wildflower Seed Mix

Lance Leaved Coreopsis

Oxeye Daisy White Yarrow

Park Mix

SEED TYPE

Kentucky

Black Eyed Susan

Creeping Red Fescue

Bioswale Seed Mix

Turf Type Tall Fescue Smooth Bromegrass Creeping Red Fescue Kentucky Bluegrass

Improved Perennial Rye

Application Rate: .50 lbs. / 1,000 sf

Application Rate: 3.5 lbs. / 1,000 sf

Application Rate: 2.5 lbs / 1,000 sf.

- 14. PRUNE NEWLY PLANTED TREES AND SHRUBS ONLY AS DIRECTED BY LANDSCAPE ARCHITECT.
- 15. SUBSTITUTIONS ON PLANT MATERIALS MUST BE APPROVED BY LANDSCAPE ARCHITECT PRIOR TO PLANTING. PROVIDE MATCHING FORMS AND SIZES FOR PLANT MATERIALS WITHIN EACH SPECIES AND SIZE DESIGNATED ON THE DRAWINGS.
- . LOAM AND SEED AS PER SPECIFICATIONS AND AS PER SEED MIXES SPECIFIED ON DRAWINGS.


% BY WEIGHT

% BY WEIGHT

% BY WEIGHT

SITE PREPARATION NOTES:

- . THE CONTRACTOR SHALL VISIT THE SITE TO VERIFY EXISTING CONDITIONS AND TO BECOME THOROUGHLY FAMILIAR WITH THE PROJECT AND THE SITE PRIOR TO COMMENCING THE WORK IT IS THE CONTRACTOR'S RESPONSIBILITY TO FIELD VERIFY ACTUAL SITE CONTOURS PRIOR TO THE START OF ANY WORK. ANY DISCREPANCY FOUND SHALL BE BROUGHT TO THE IMMEDIATE ATTENTION OF THE LANDSCAPE ARCHITECT AND OWNER PRIOR TO THE START OF ANY WORK.
- 2. THE CONTRACTOR SHALL CONTACT "DIG-SAFE", OBTAIN A REGISTRATION NUMBER AND NOTIFY LANDSCAPE ARCHITECT PRIOR TO THE START OF CONSTRUCTION.
- 3. ALL DIMENSIONS SHALL BE VERIFIED IN THE FIELD BY THE CONTRACTOR. 4. THE PROJECT SITE SHALL BE CLEANED DAILY AND SHALL REMAIN FREE OF ANY DEBRIS OR
- HAZARDS THAT CAN CAUSE INJURY. THE OWNERS AND VISITORS MUST HAVE CLEAR ACCESS TO THE SITE AT ALL TIMES. 5. NO STORAGE OF MATERIAL IS ALLOWED WITHIN THE DRIPLINE OF TREES TO REMAIN.
- 6. ALL CONSTRUCTION SHALL BE IN ACCORDANCE WITH ALL STATE AND MUNICIPAL CODES AND
- 7. STOCKPILE TOPSOIL AND OTHER NECESSARY CONSTRUCTION MATERIAL IN AREA DESIGNATED ON PLANS AND/OR AS DIRECTED BY LANDSCAPE ARCHITECT. 8. PROTECT ALL EXISTING PLANTS AND HARDSCAPES TO REMAIN. PROTECT BUILDING FROM CONSTRUCTION WORK. THE CONTRACTOR SHALL REPAIR ANY DAMAGE INCURRED AS A RESULT OF THE CONTRACTOR'S OPERATIONS TO THE BUILDING AND EXISTING SITE ELEMENTS TO REMAIN. THE CONTRACTOR SHALL BEAR THE COST OF THE REPAIR.
- IN AREAS DESIGNATED FOR NEW PLANT BEDS. UNSUITABLE MATERIAL SHALL BE AS PER SOIL TEST AND AS INDICATED BY THE LANDSCAPE ARCHITECT. 10. DISPOSE OF ALL UNSUITABLE MATERIAL IN ACCORDANCE WITH STATE AND MUNICIPAL
- II. PROTECT AND SECURE ALL STOCKPILED MATERIALS FROM WEATHER AND POSSIBLE VANDALISM. DO NOT ALLOW STOCKPILED TOPSOIL TO RUN OFF THE SITE. 12. THE CONTRACTOR SHALL MAINTAIN POSITIVE DRAINAGE AT ALL TIMES.

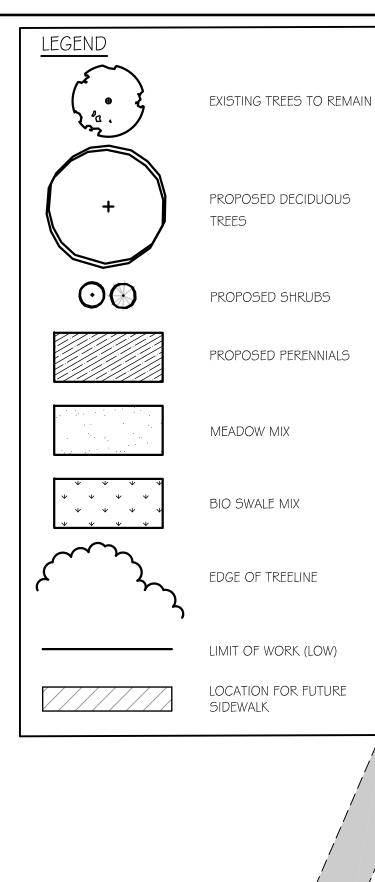

LOCATION

EXISTING BUILDING

WILD FLOWER MIX

476 MAIN ST.

LIGHT POLE REFER

LIGHT POLE REFER

TO ENG. PLANS

TO ENG. PLANS



COMMERCIAL PROPERTY 470 MAIN STREET BOLTON, MASSACHUSETTS

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NOTES

POTENTIAL FUTURE SIDEWALK ROUTE.O

AT FUTURE DATE

WF B26

11/2 WF B24

--- BIO SWALE MIX

BIO SWALE MIX

SCALE: 1:20


DETAILS TO BE FINALIZED

-WF *B30*


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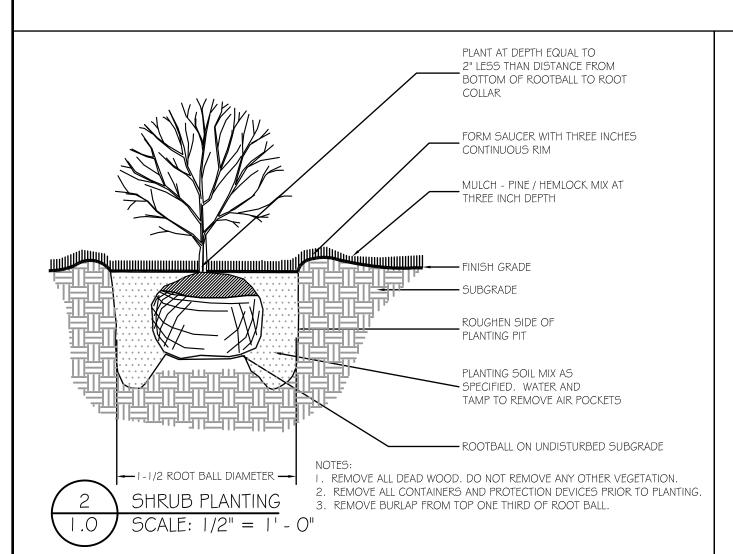
REVISIONS


(2) 12-3-15 REVISIONS AS PER PLANNING BOARD COMMENTS (2) OF 11-28-15

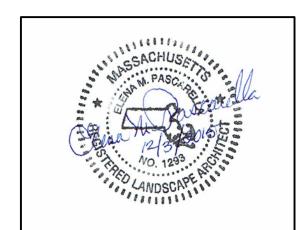


STAMPS



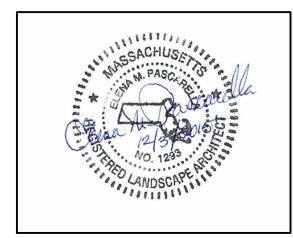

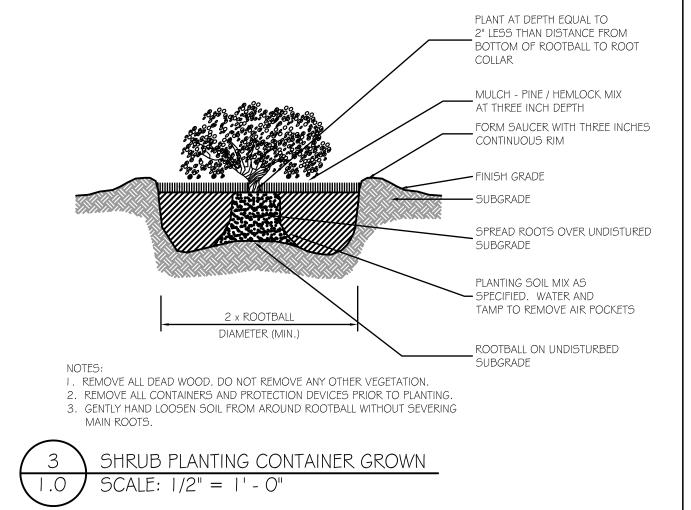

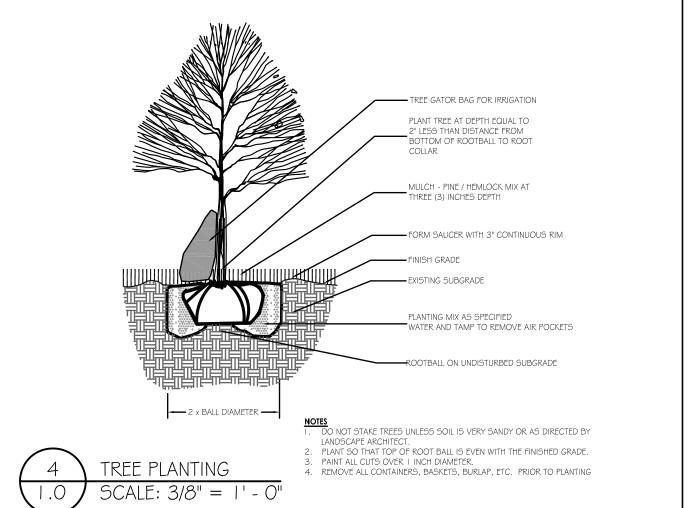

BENCHMARK: PK NAIL IN POLE

WITH PARK MIX

PROPOSED RETAIL BLDG.

2,400 SF FOOTPRINT


BIKE RACK

(2 BIKES

LEACHING CHAMBERS -

REFER TO ENGINEERING

ELEVATION= 101.12

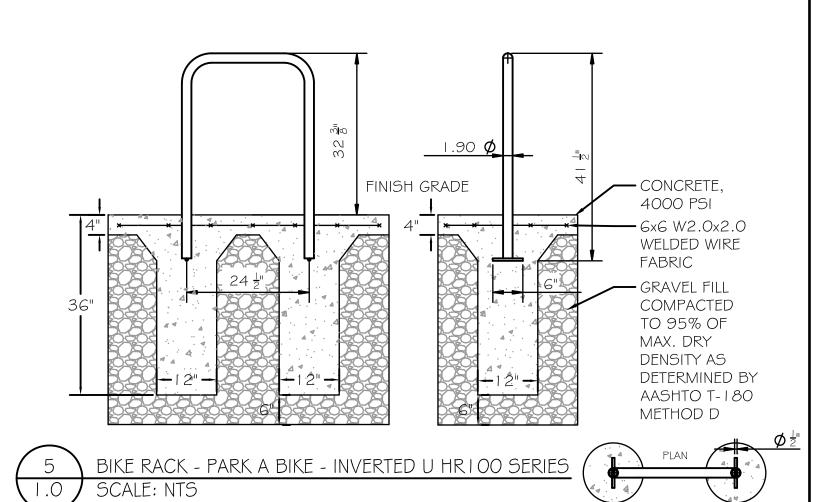

REFER TO ENGINEERING PLANS

FIRST BOLTON LAND, LLC

MAP 4D PCL 30

MAIN STREET

SEE PLAN BY ROSS ASSOCIATES NOV. 2011

DATE: JOB NO. **DRAWN BY: CHECKED BY:**

DRAWING TITLE: **PLANTING PLAN AND PLANTING DETAILS**

12-03-15

014-046

NJZ

EMP

SHEET NO. LA-1.0